

SCALE: 1" = 1000'

### LIST OF DRAWINGS

C-303 DETAILS

C-304 DETAILS

DRAWING #	TITLE	SHEET#
O-100	OVERALL PLAN	1
C-101	SITE PLAN	2
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C-103	GRADING, DRAINAGE & UTILITY PLAN	4
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C-302	DETAILS	14
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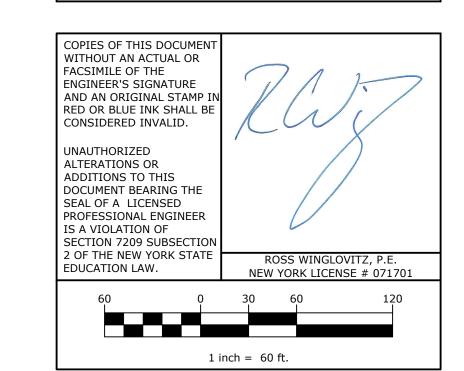


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No.	DATE	DESCRIPTION
1	01/14/22	REVISED PER PB COMMENTS 12/15/2021
2	05/13/22	REVISED LAYOUT PER TRAFFIC STUDY
3	06/10/22	REVISED PER PB COMMENTS
4	09/16/22	REVISED PER PB COMMENTS
5	12/02/22	REVISED PER PB COMMENTS 09/23/2022
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9	06/16/23	REVISED PER PB & PUBLIC COMMENTS
10	12/03/24	REVISED FOR PLANNING BOARD SUBMISSION


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☑ PLANNING BOARD APPROVAL	1	OF	16	
OCDOH REALTY SUBDIVISION APPROVAL	N/A	OF	N/A	
OCDOH WATERMAIN EXTENSION APPROVAL	N/A	OF	N/A	
☐ NYSDEC APPROVAL	N/A	OF	N/A	
□ NYSDOT APPROVAL	N/A	OF	N/A	
☐ OTHER	N/A	OF	N/A	
☐FOR BID	N/A	OF	N/A	
☐ FOR CONSTRUCTION	N/A	OF	N/A	


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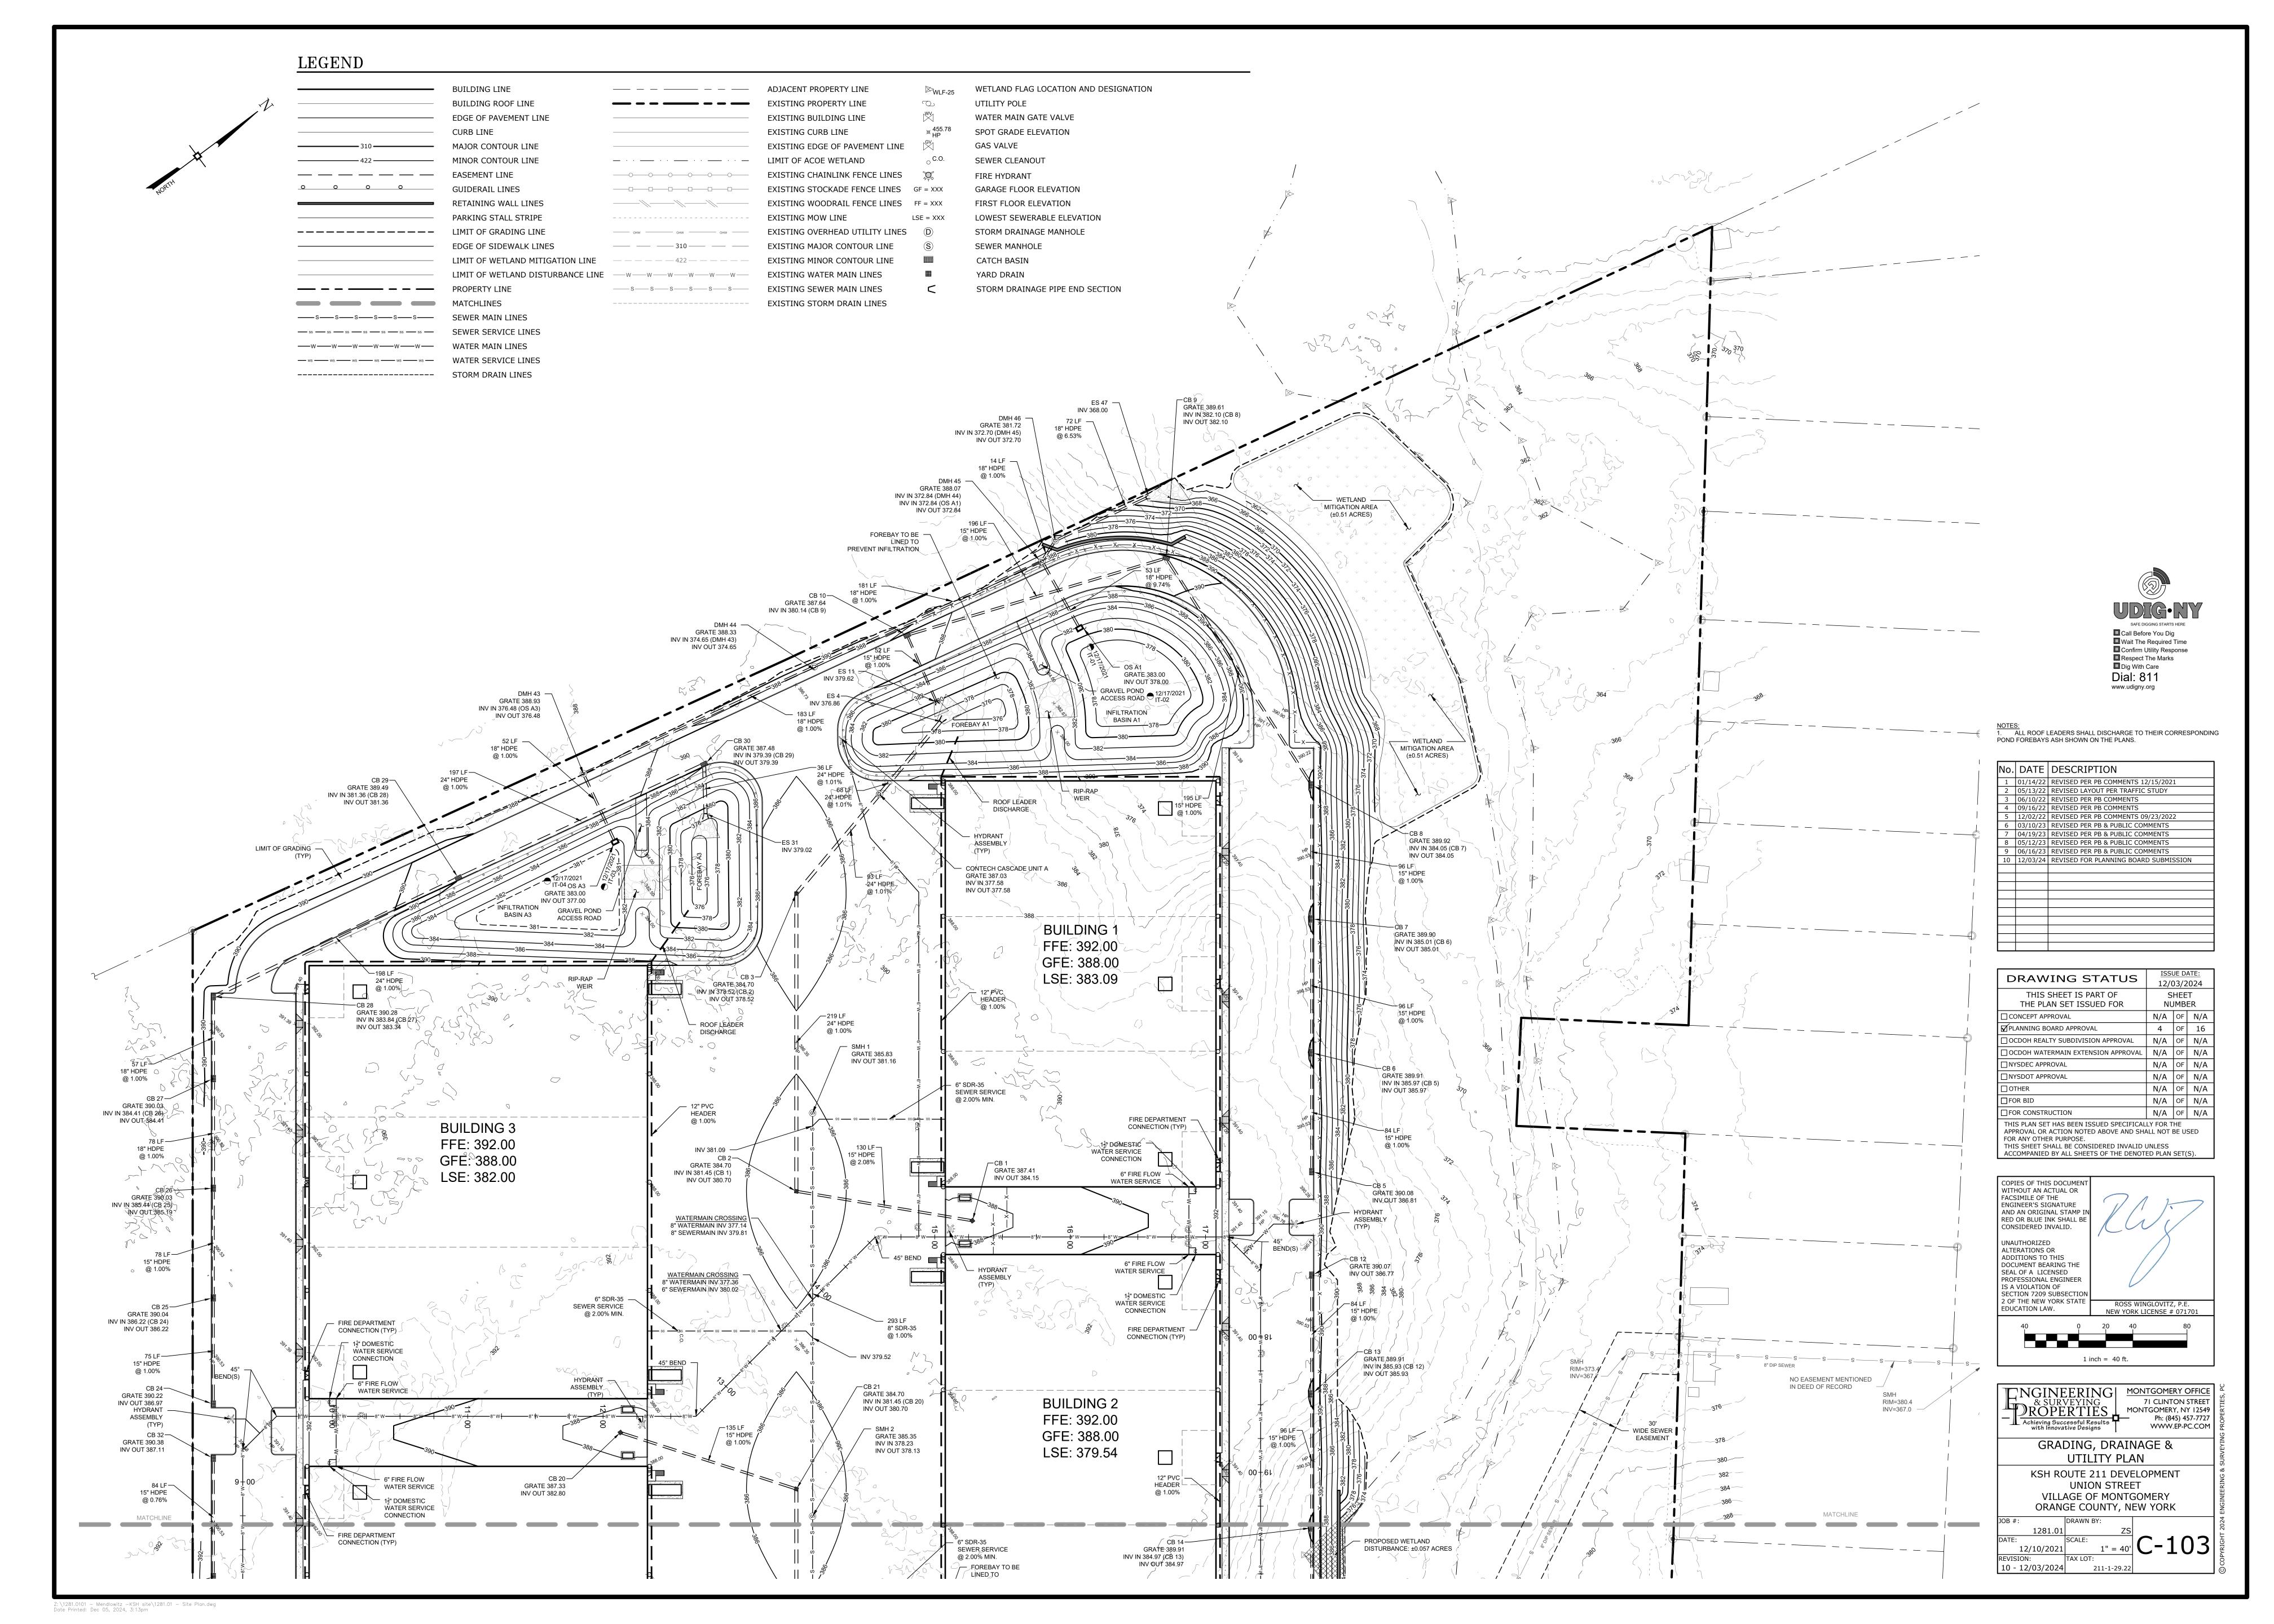



ROPI	VEYING _	10NTGOMERY OFFICE 71 CLINTON STREET 10NTGOMERY, NY 12549 Ph: (845) 457-7727 WWW.EP-PC.COM				
	OVERALL PLAN					
VILL	OUTE 211 DEV UNION STRE AGE OF MONT IGE COUNTY, N	ET GOMERY				
JOB #:	DRAWN BY:					
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12/10/202	1" = 60	'\ <i>,</i> —   \				


10 - 12/03/2024




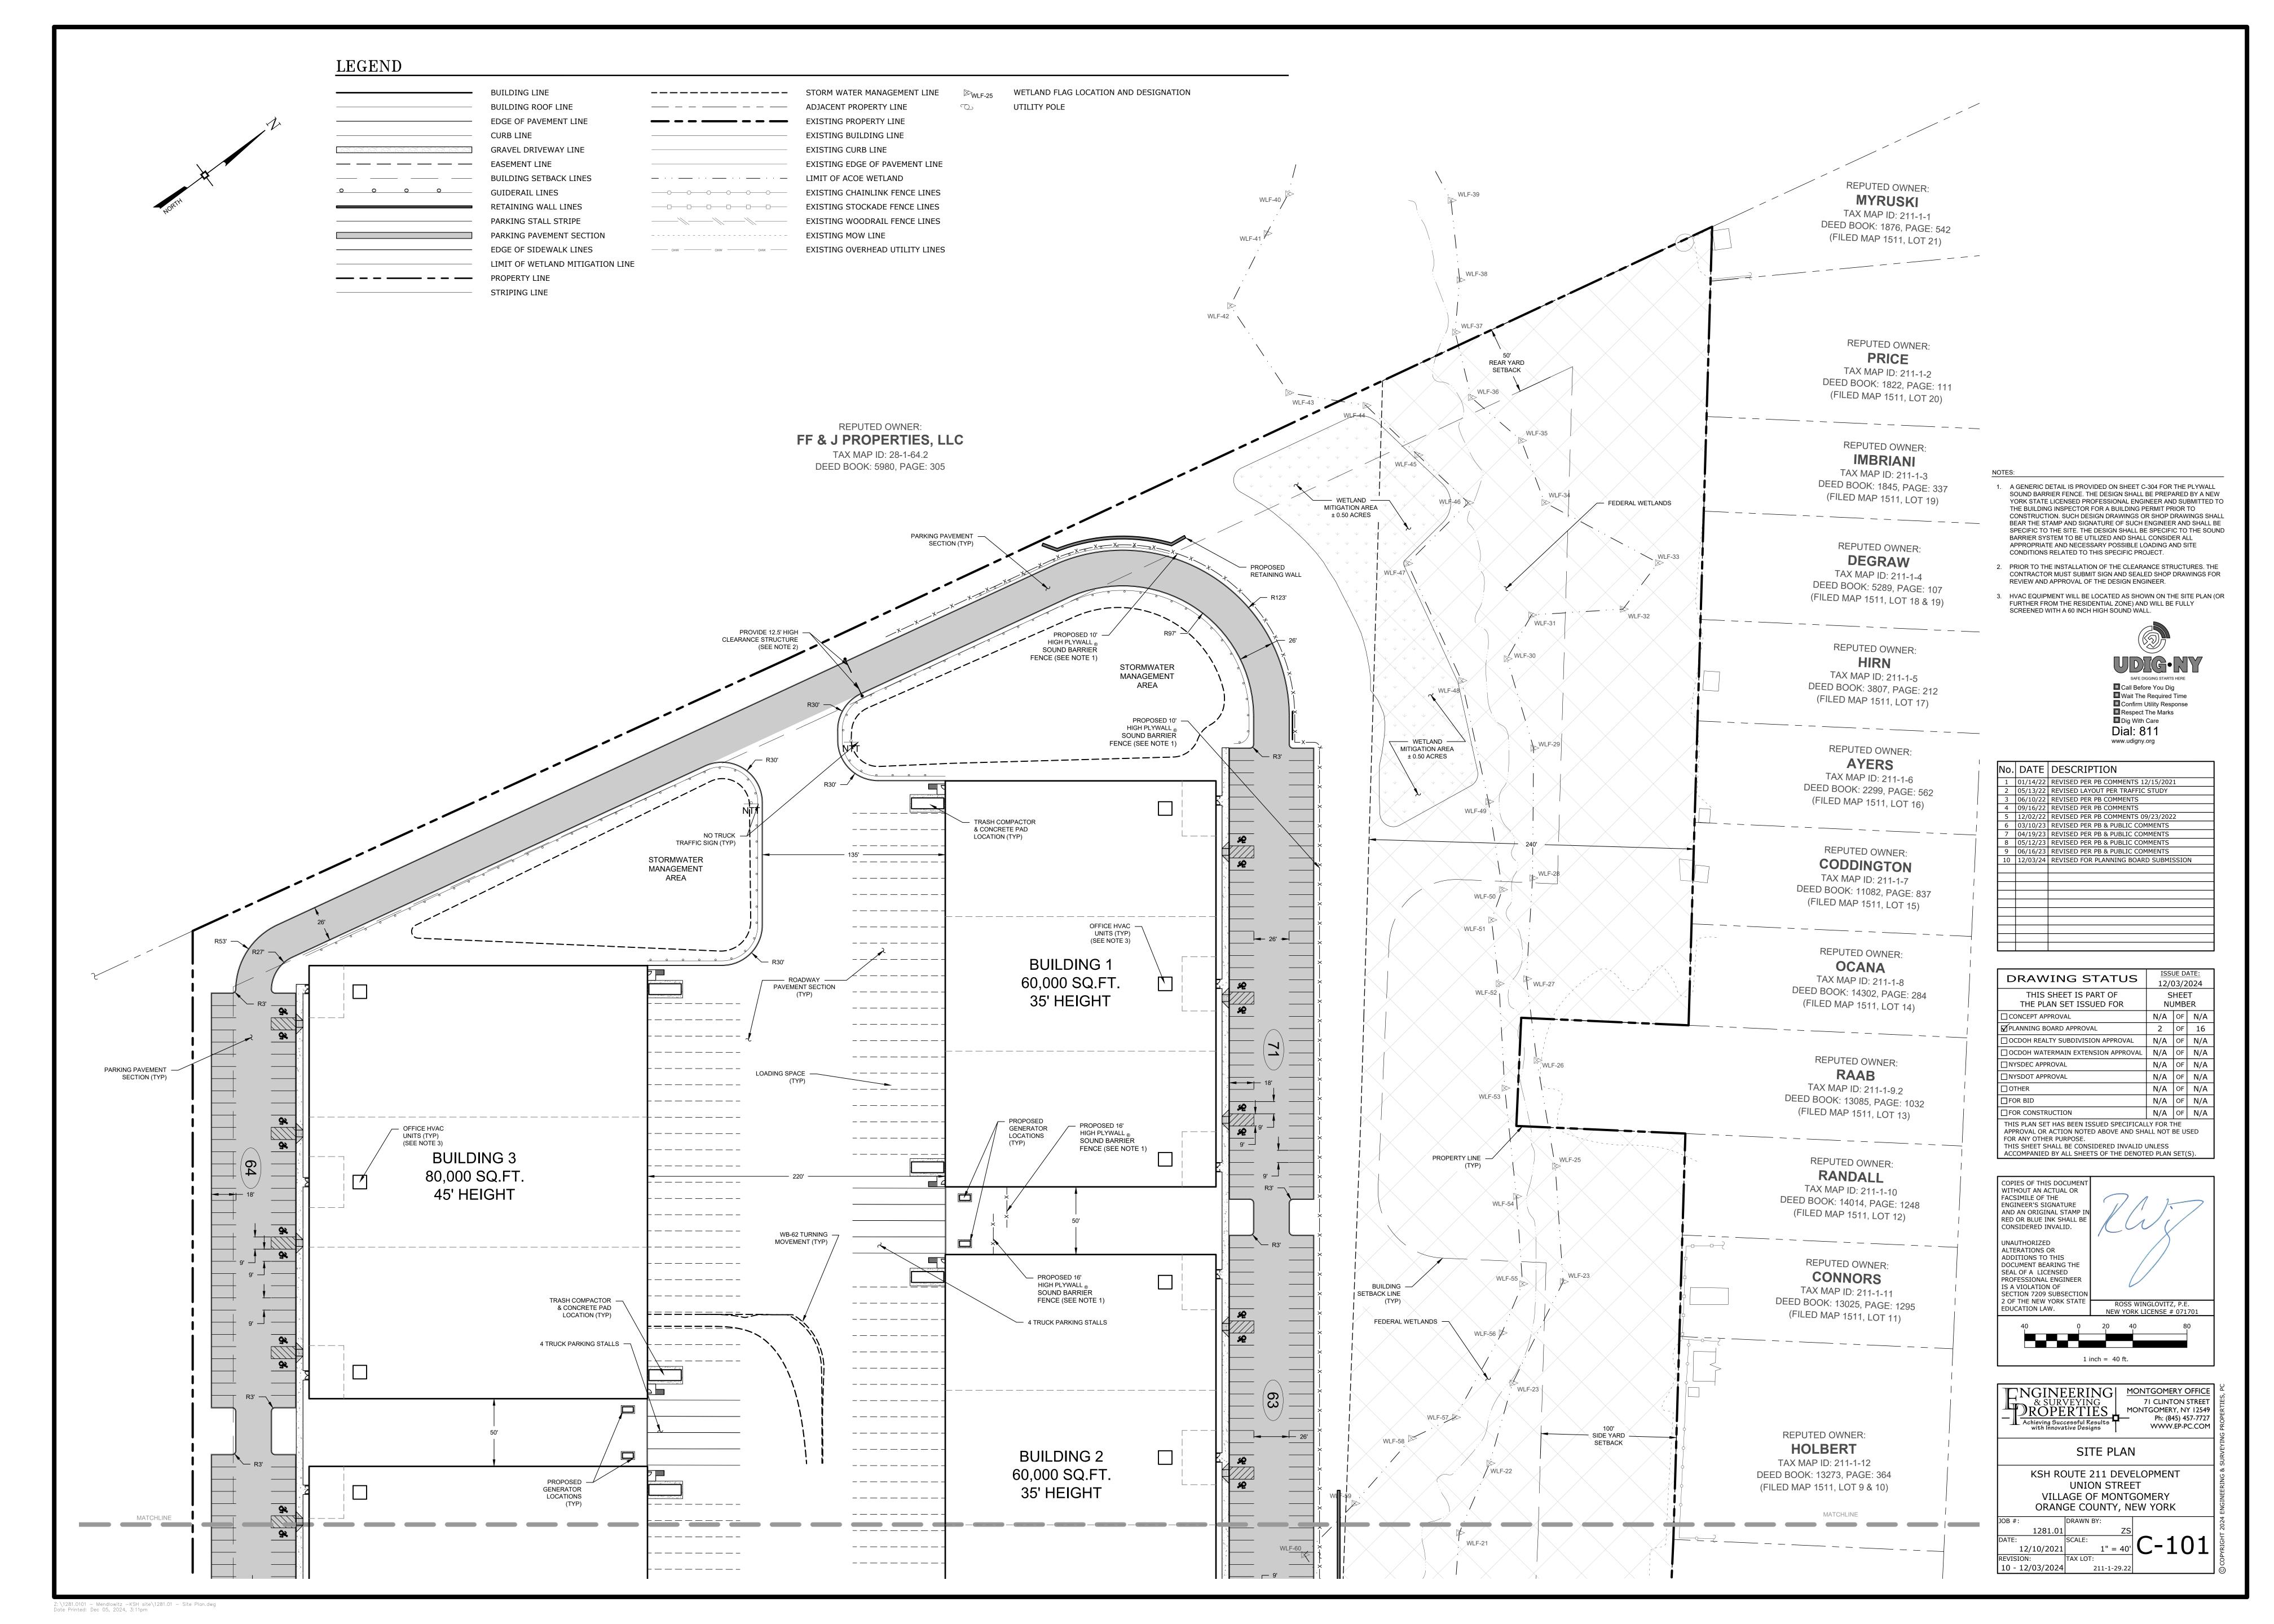


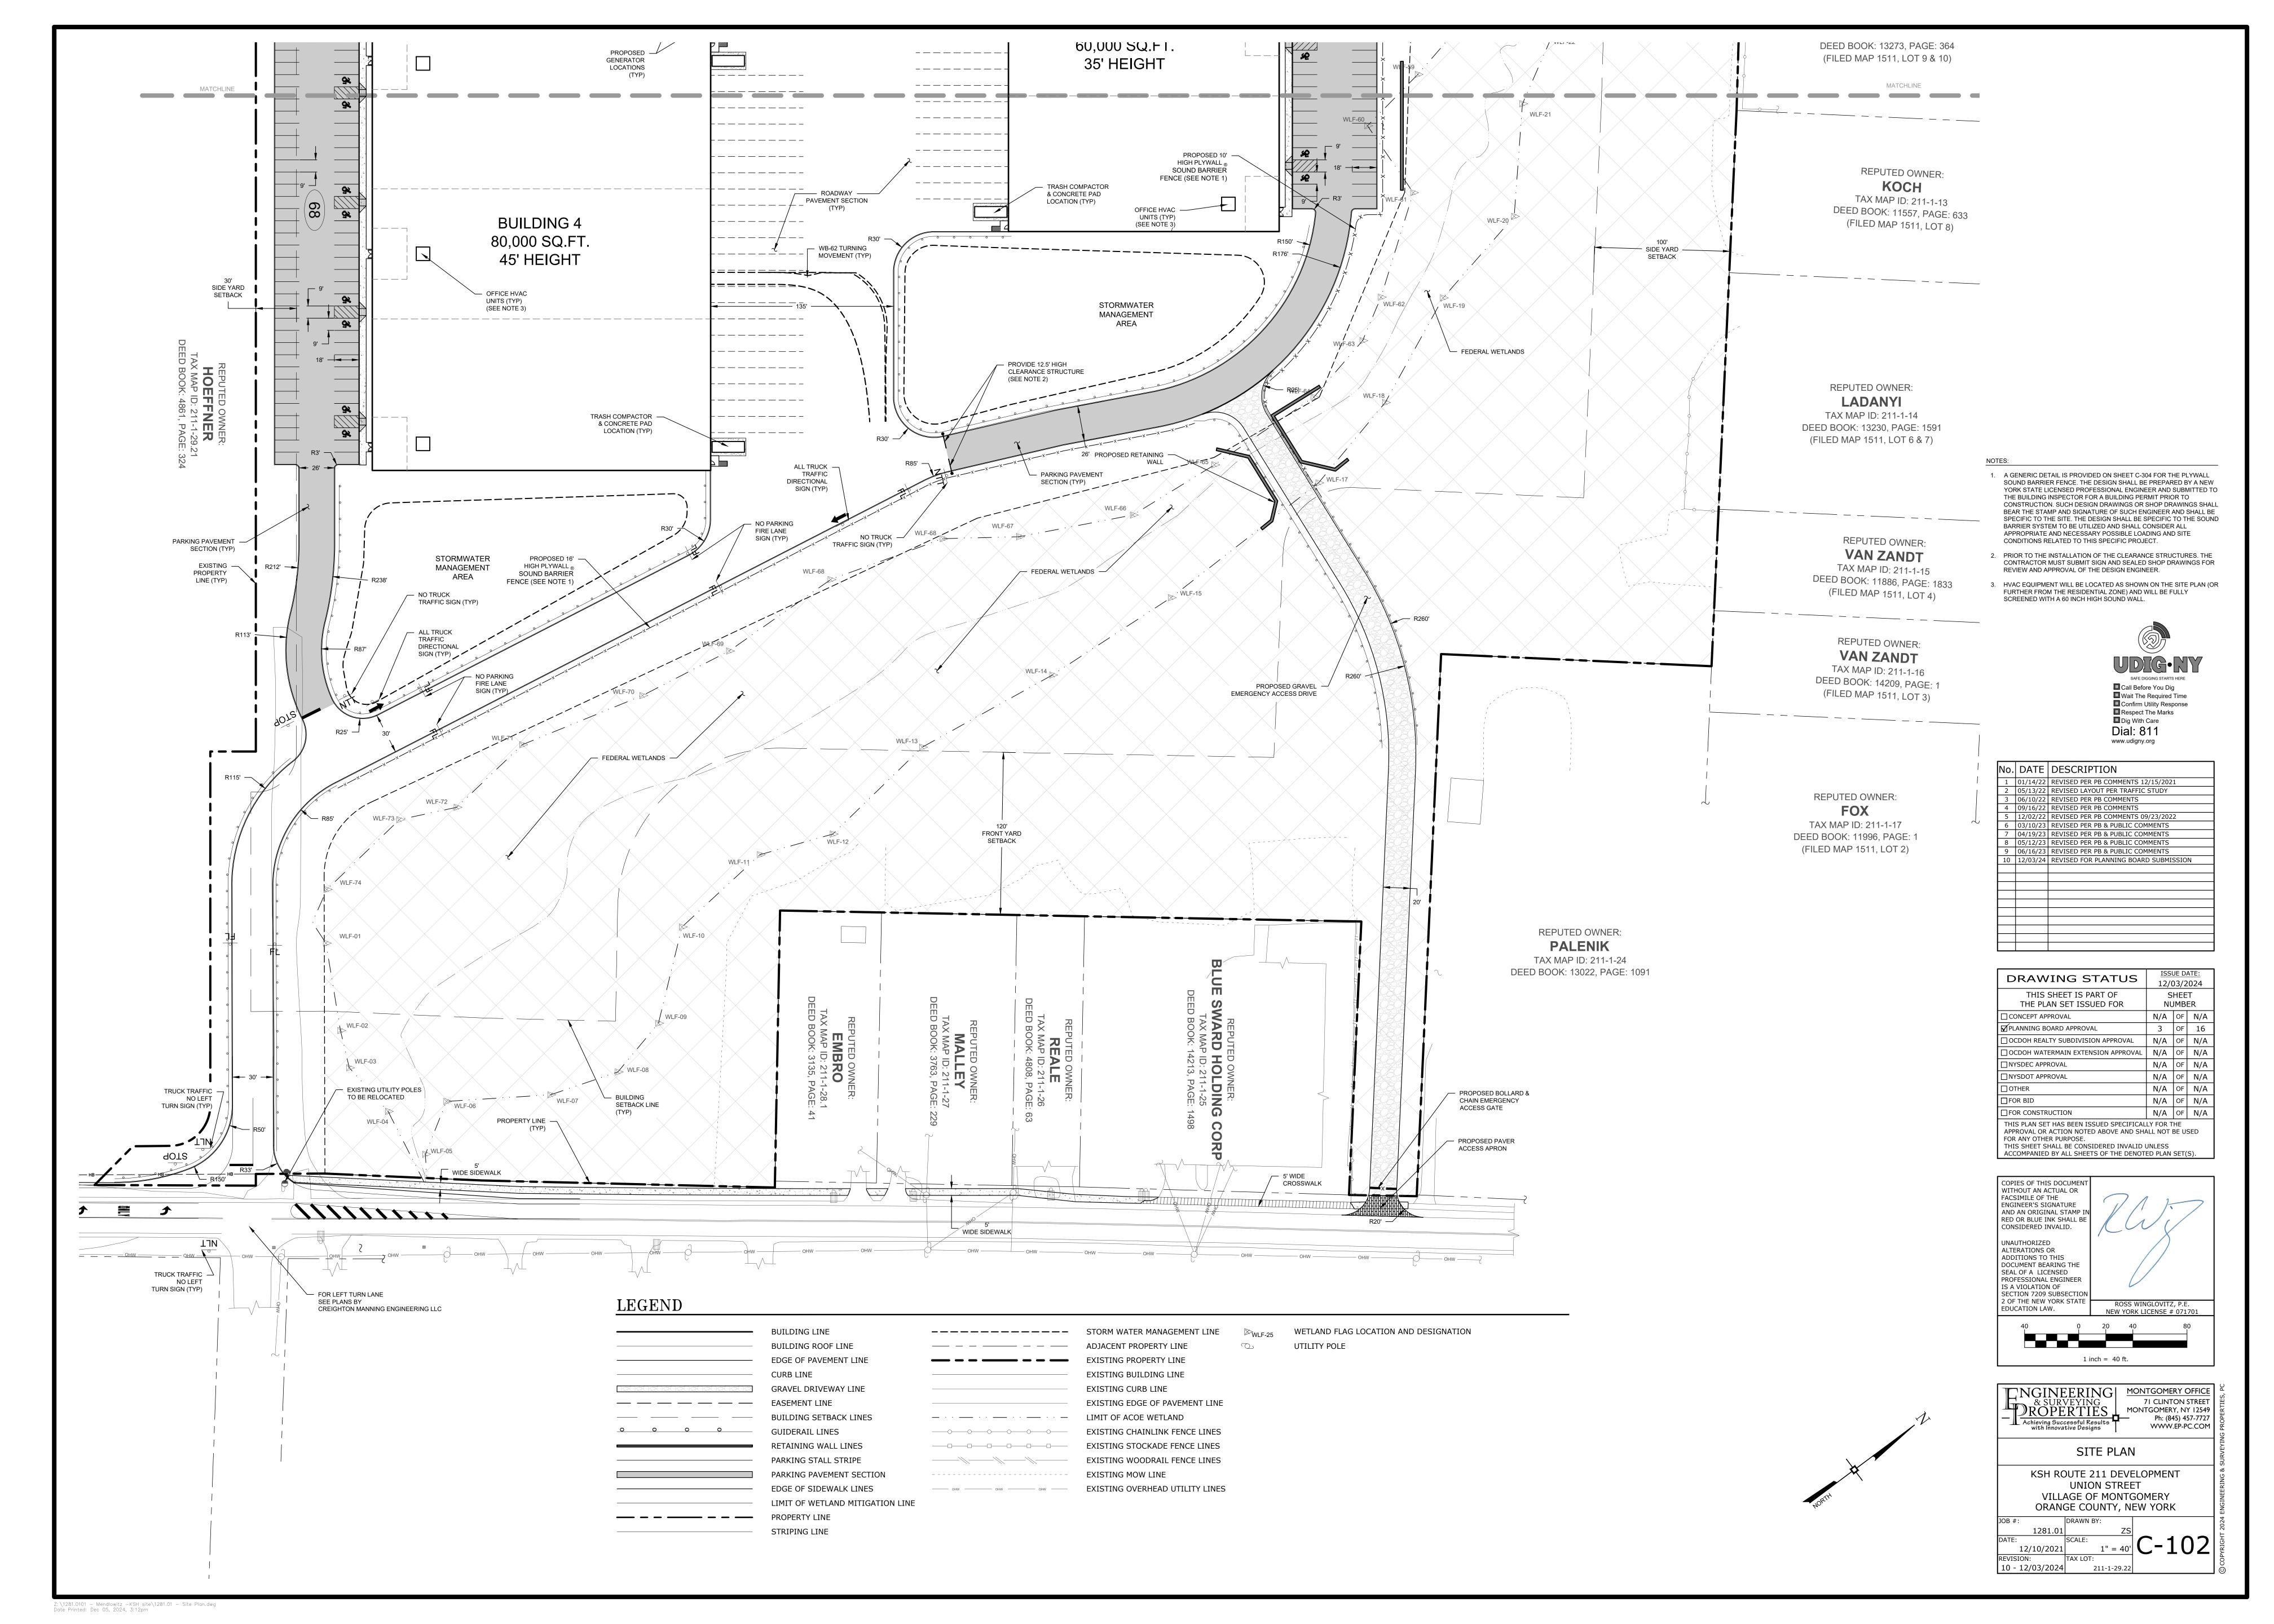

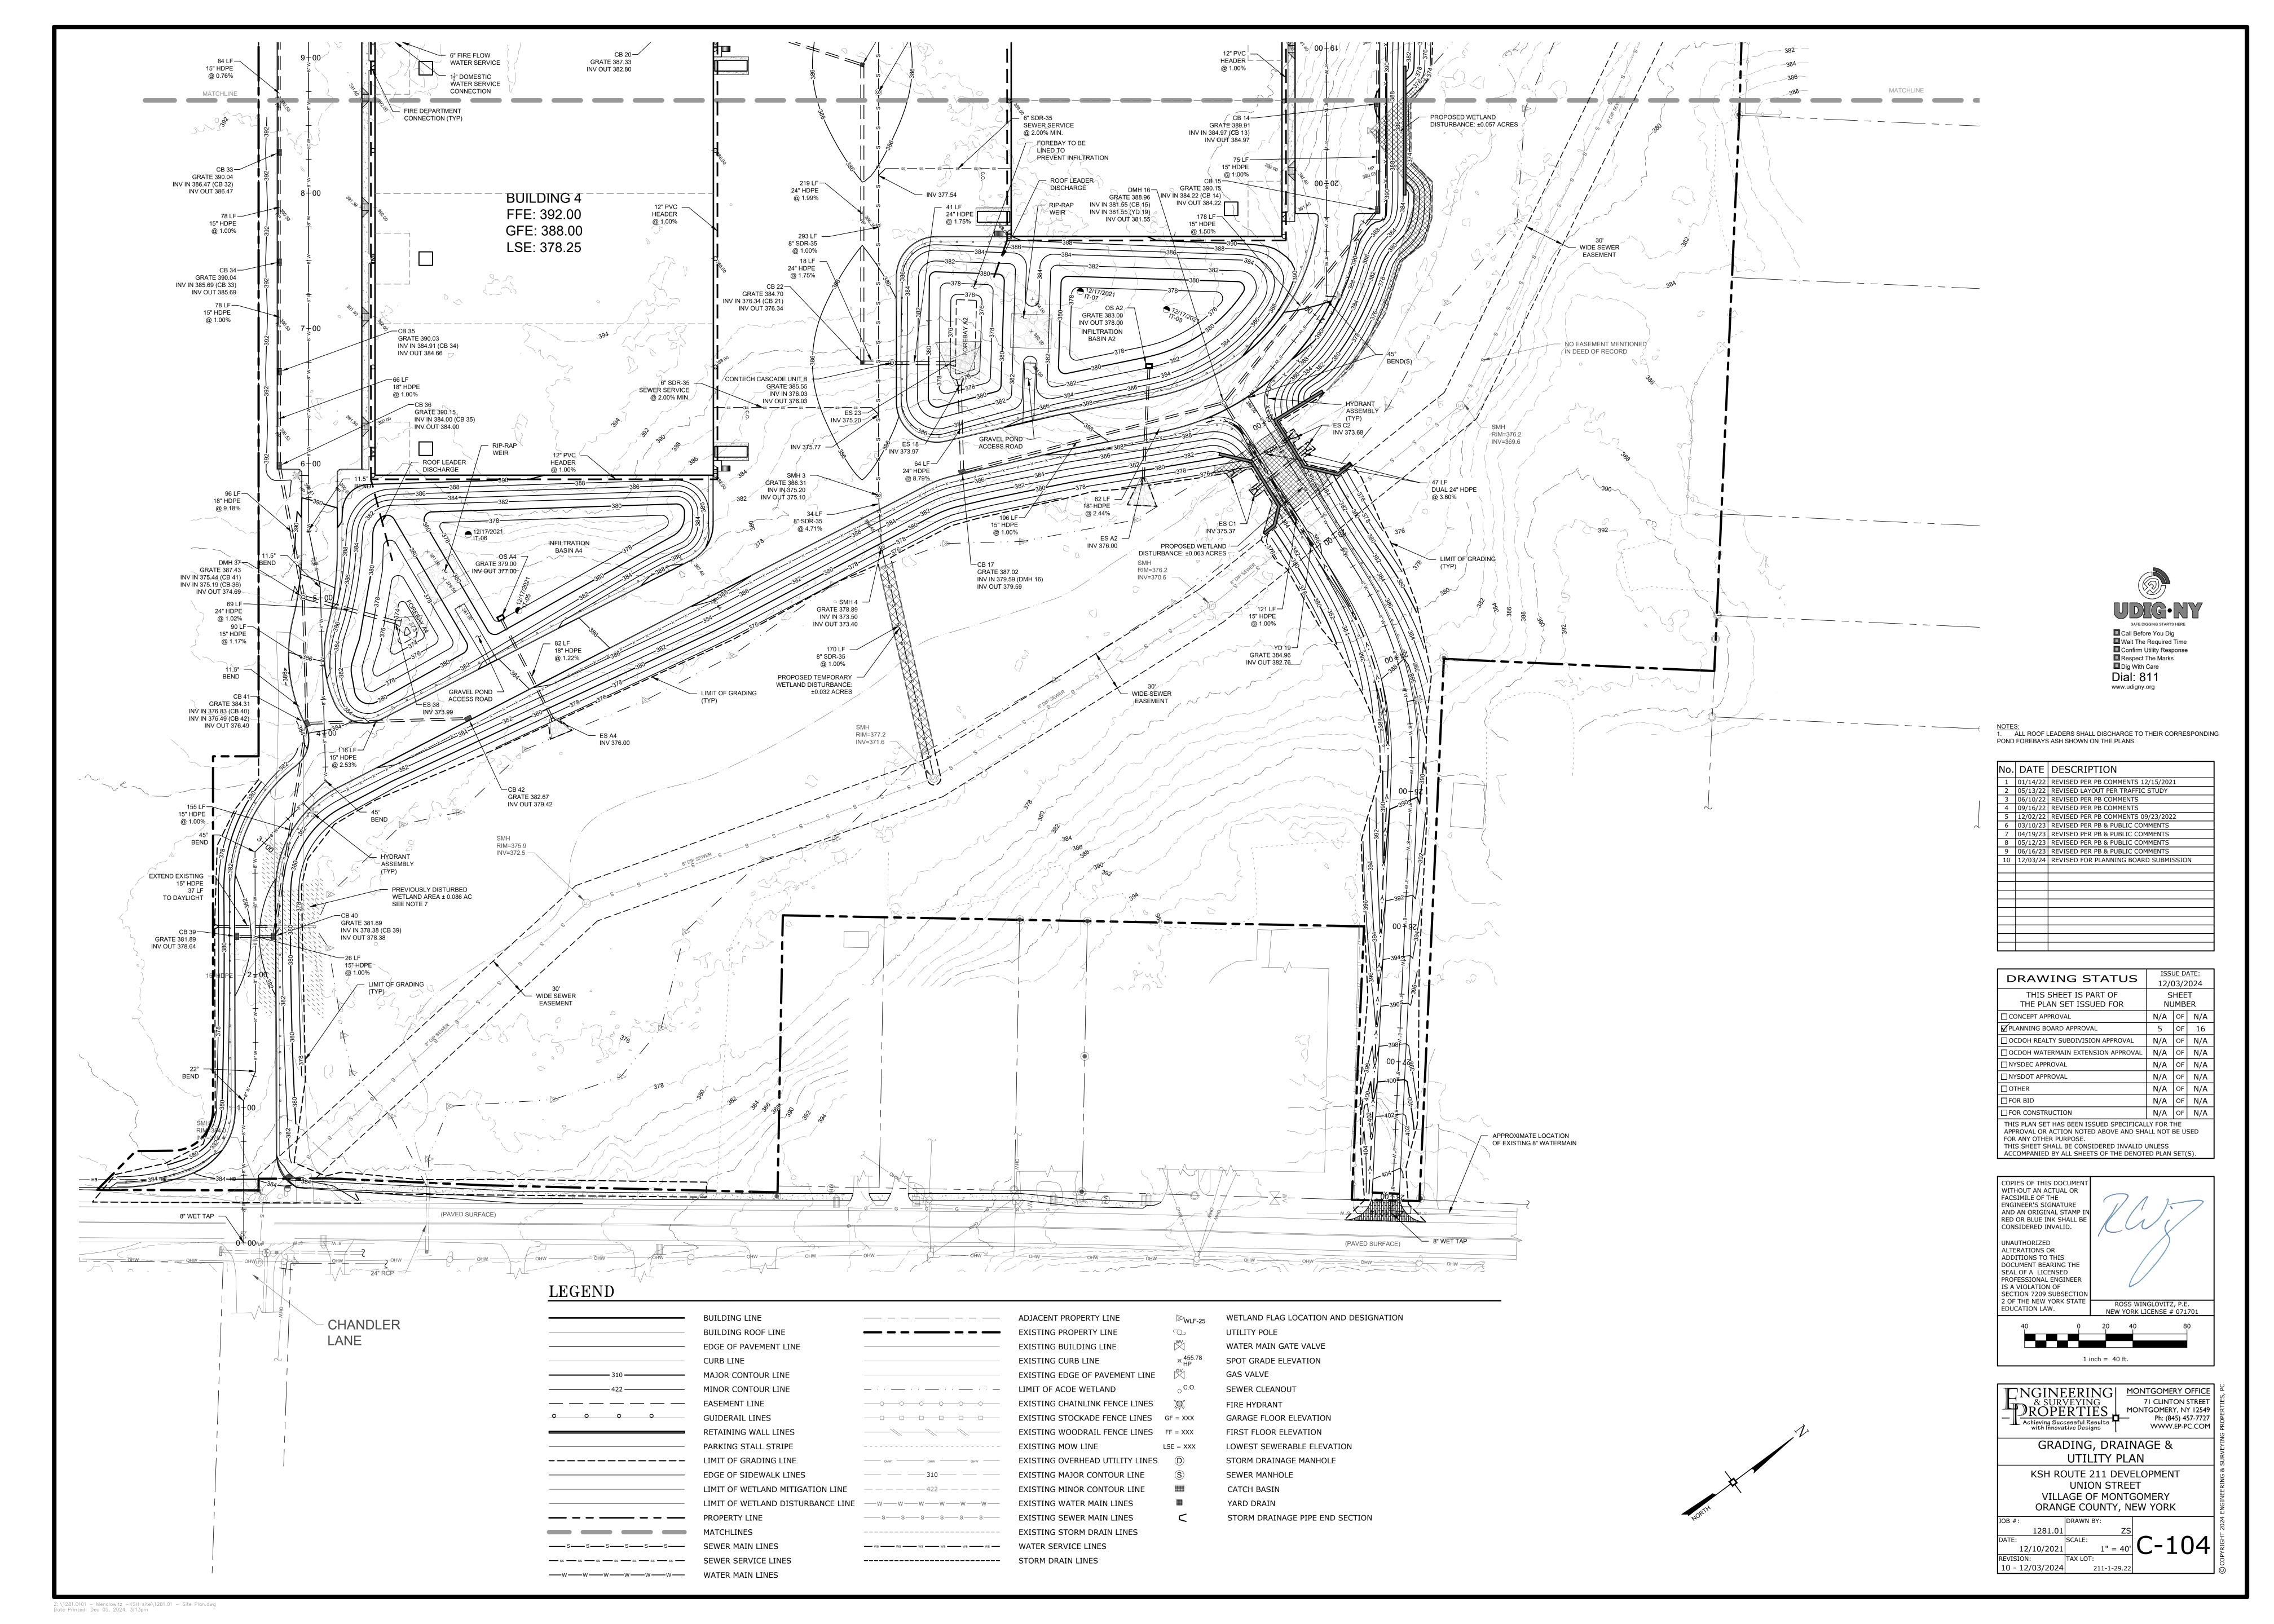

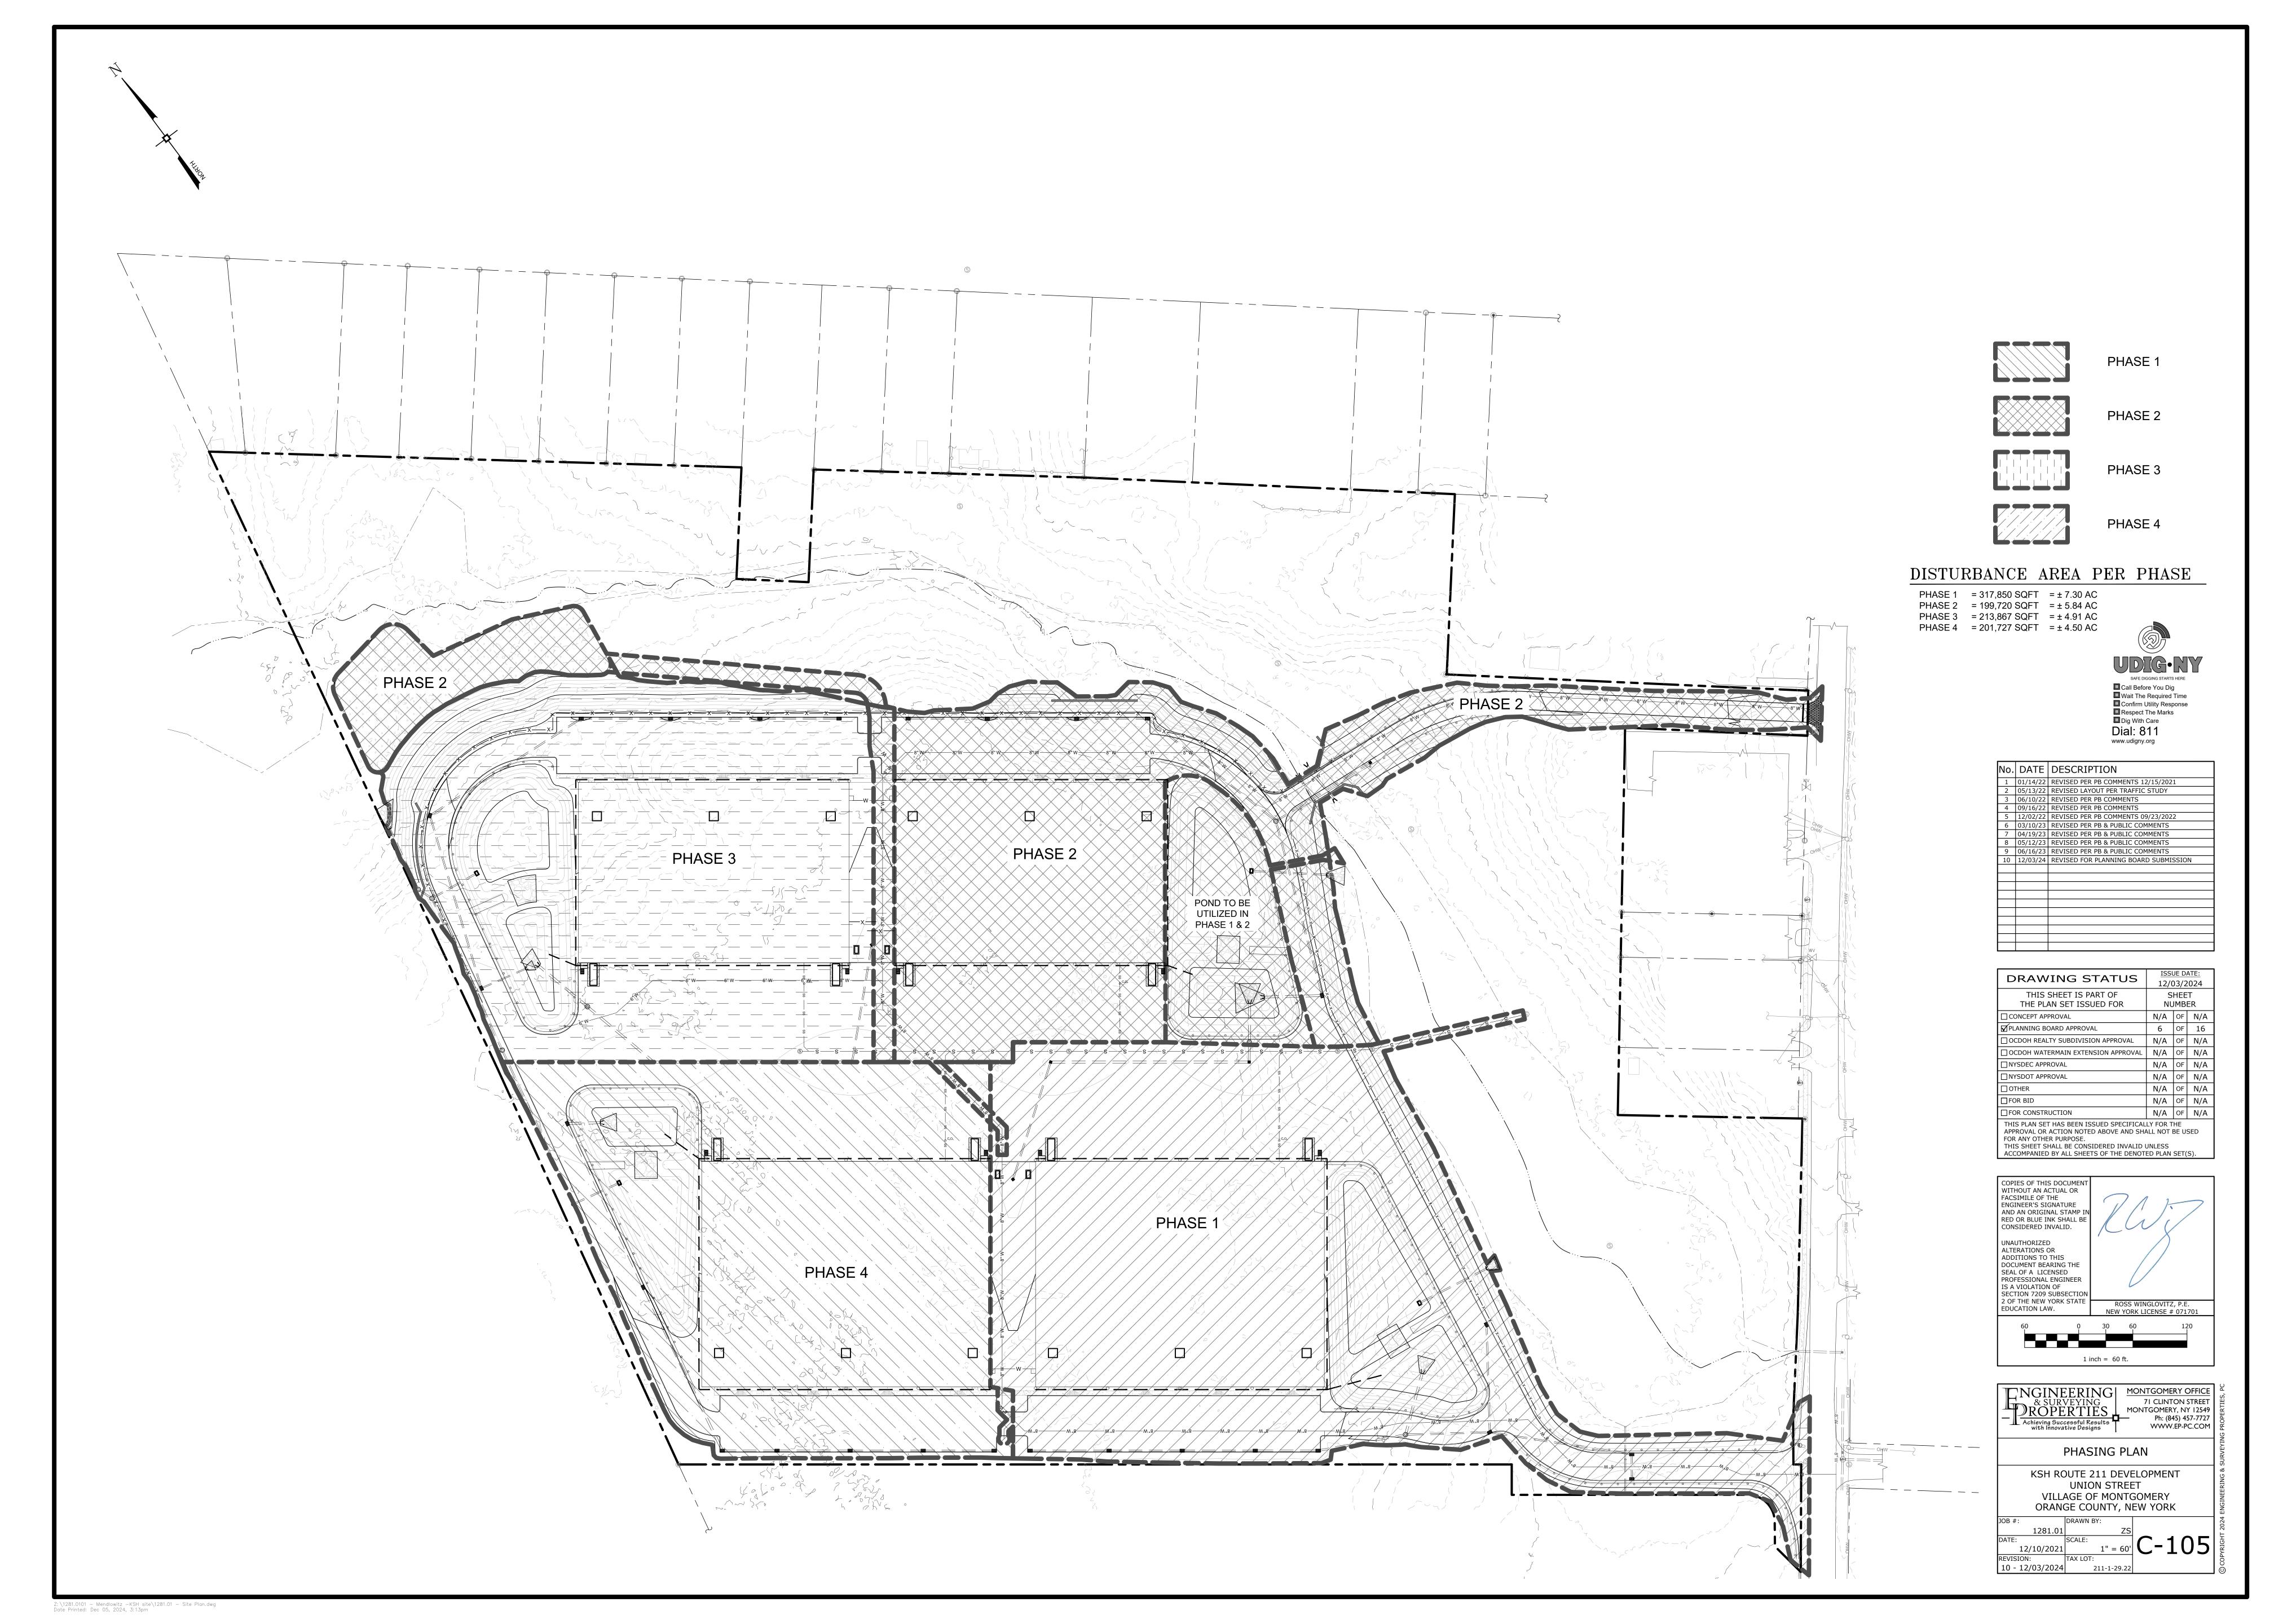


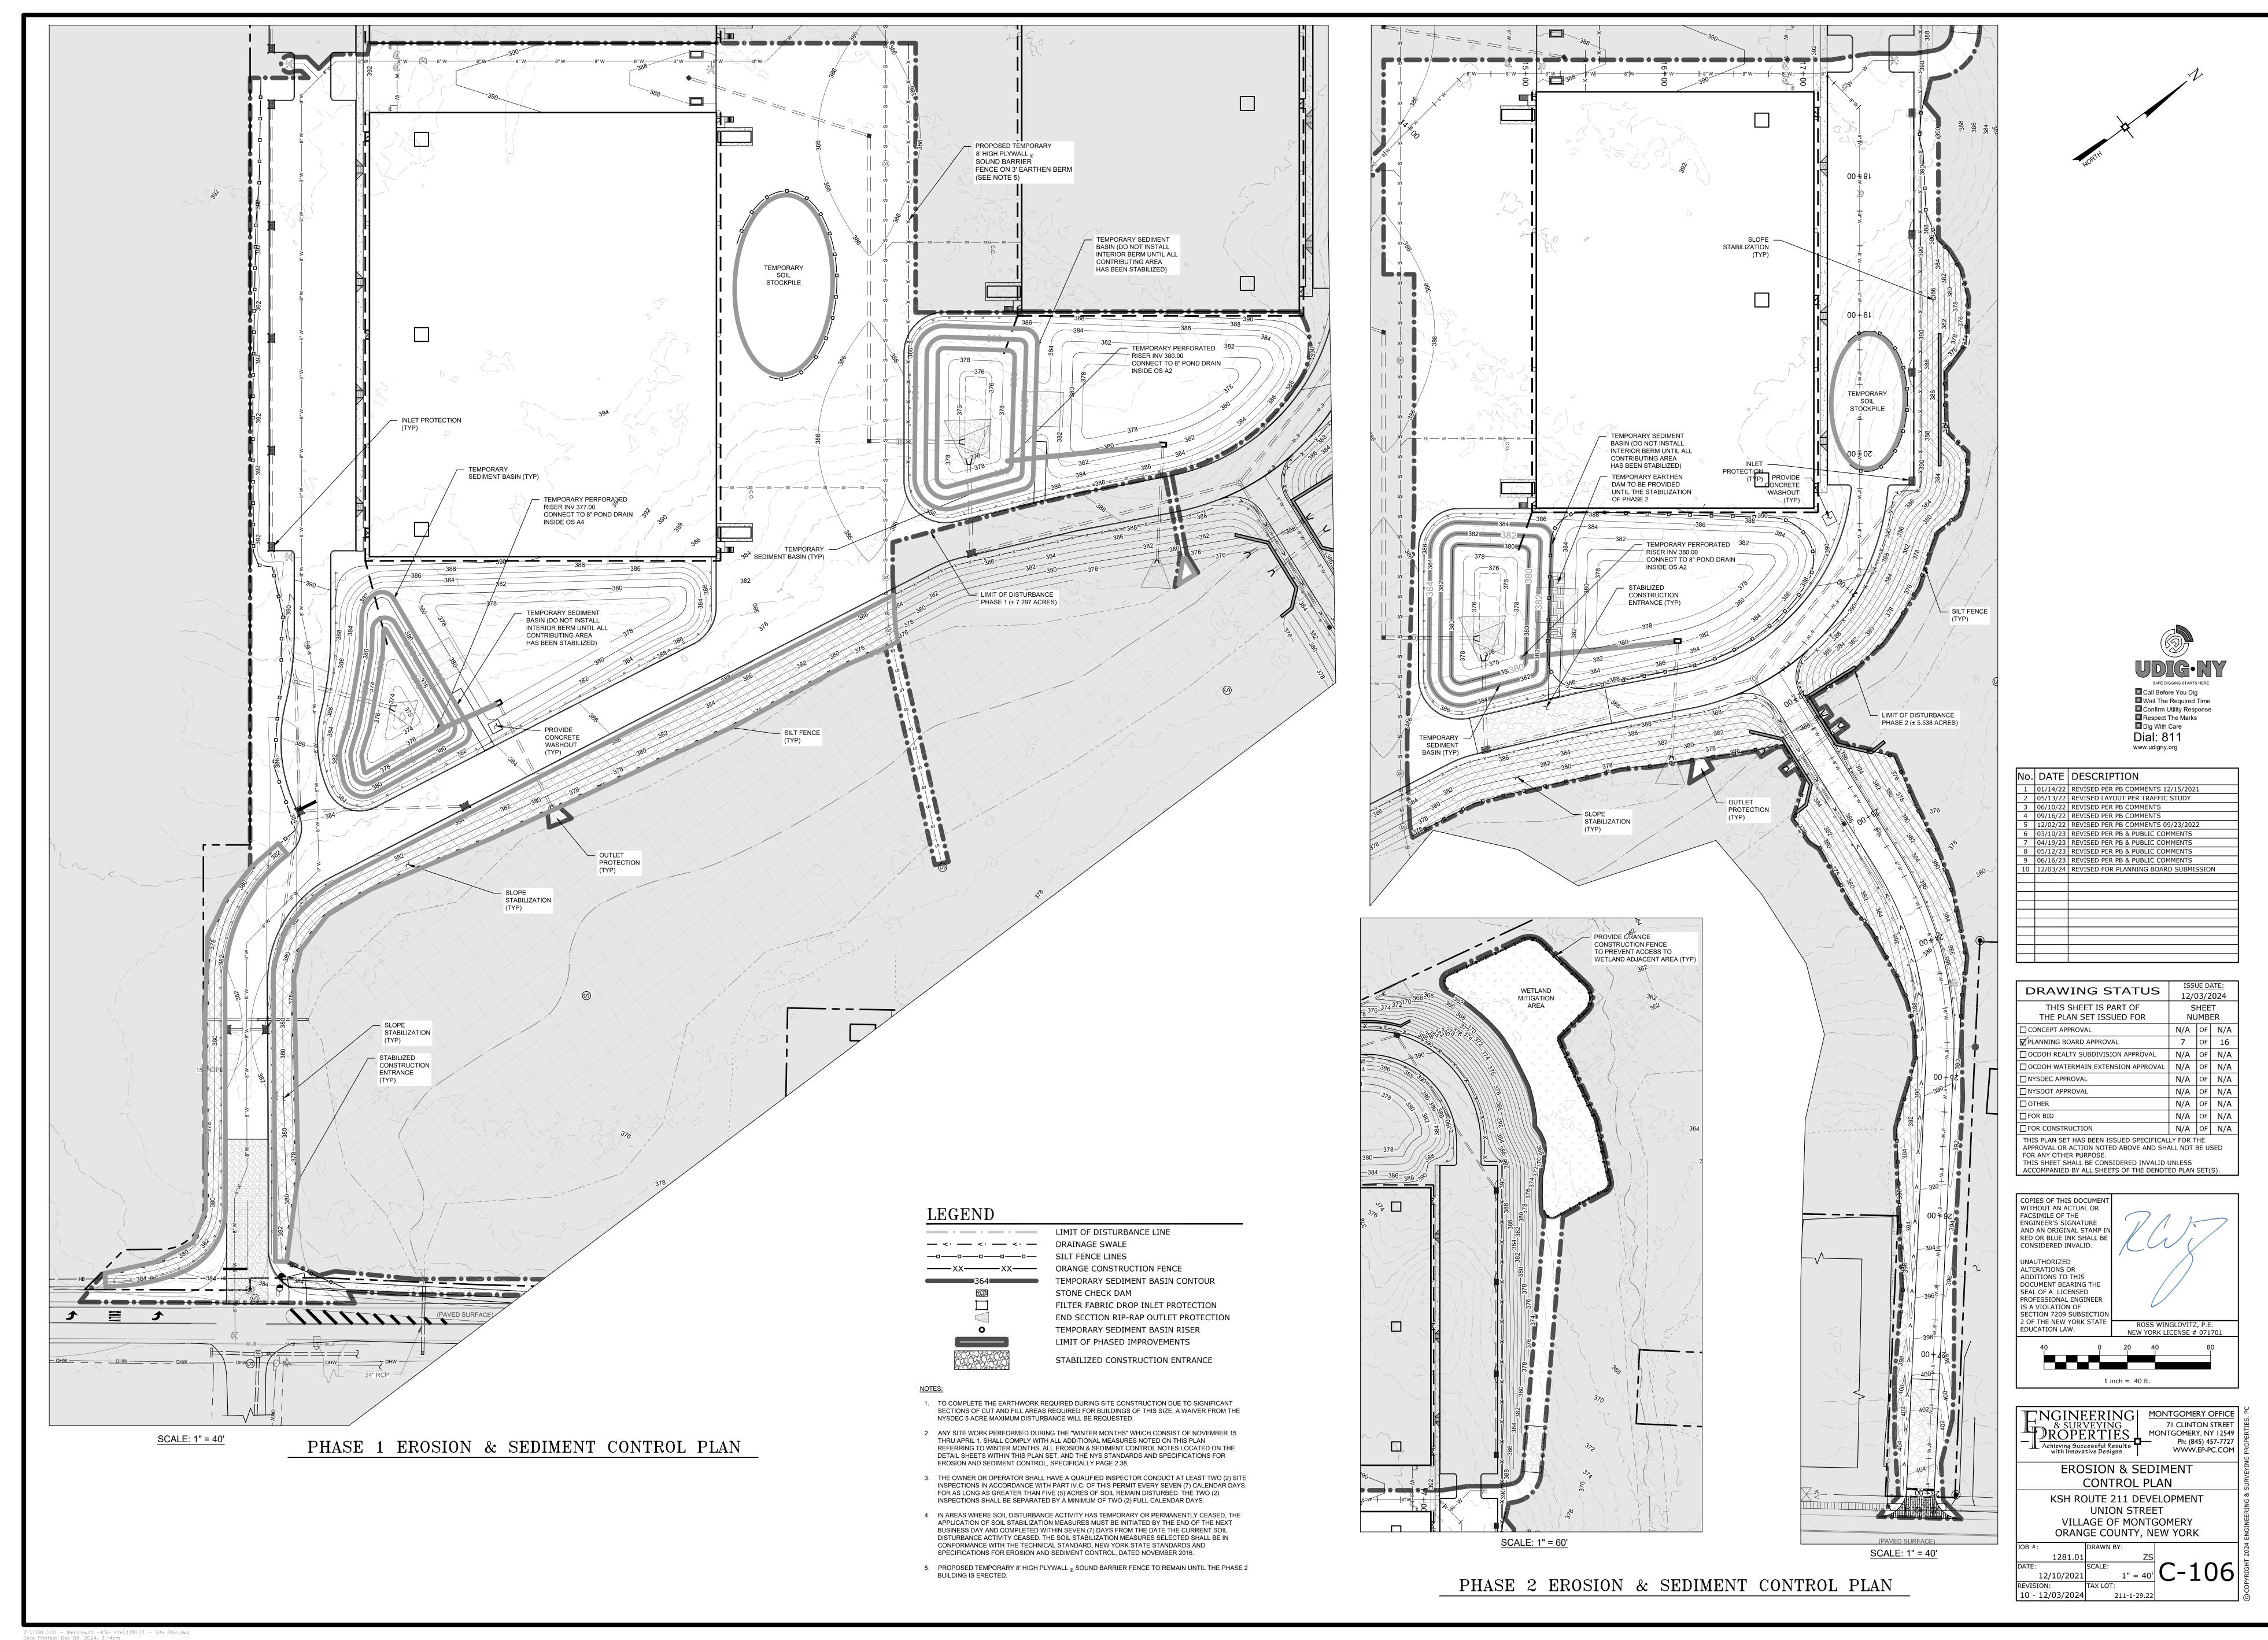


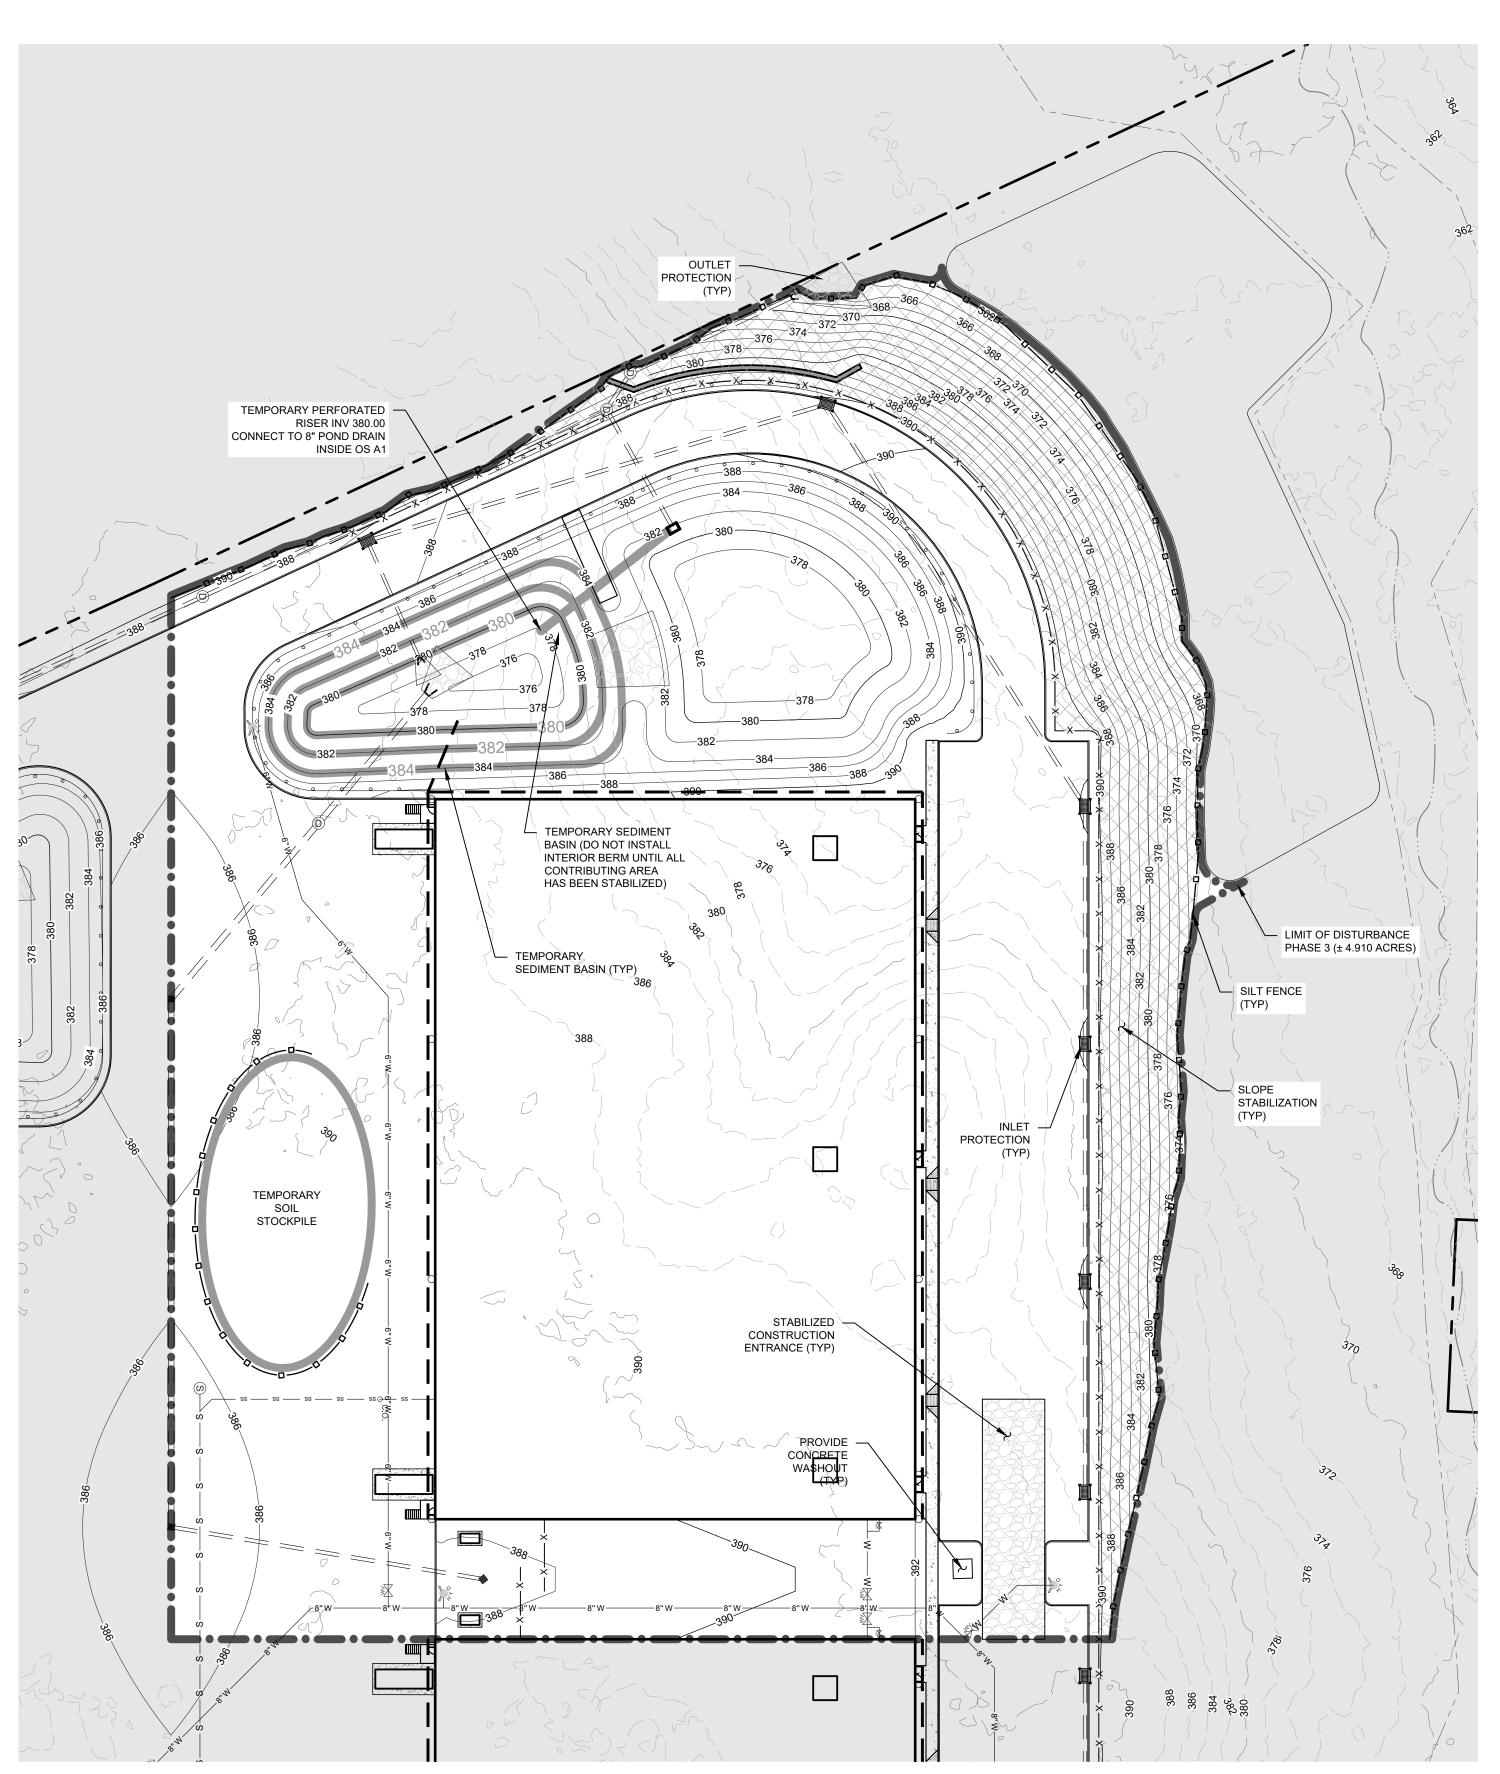

PHASE 3 EROSION & SEDIMENT CONTROL PLAN

SCALE: 1" = 40'

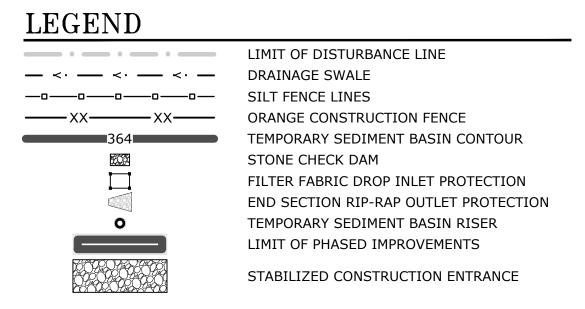

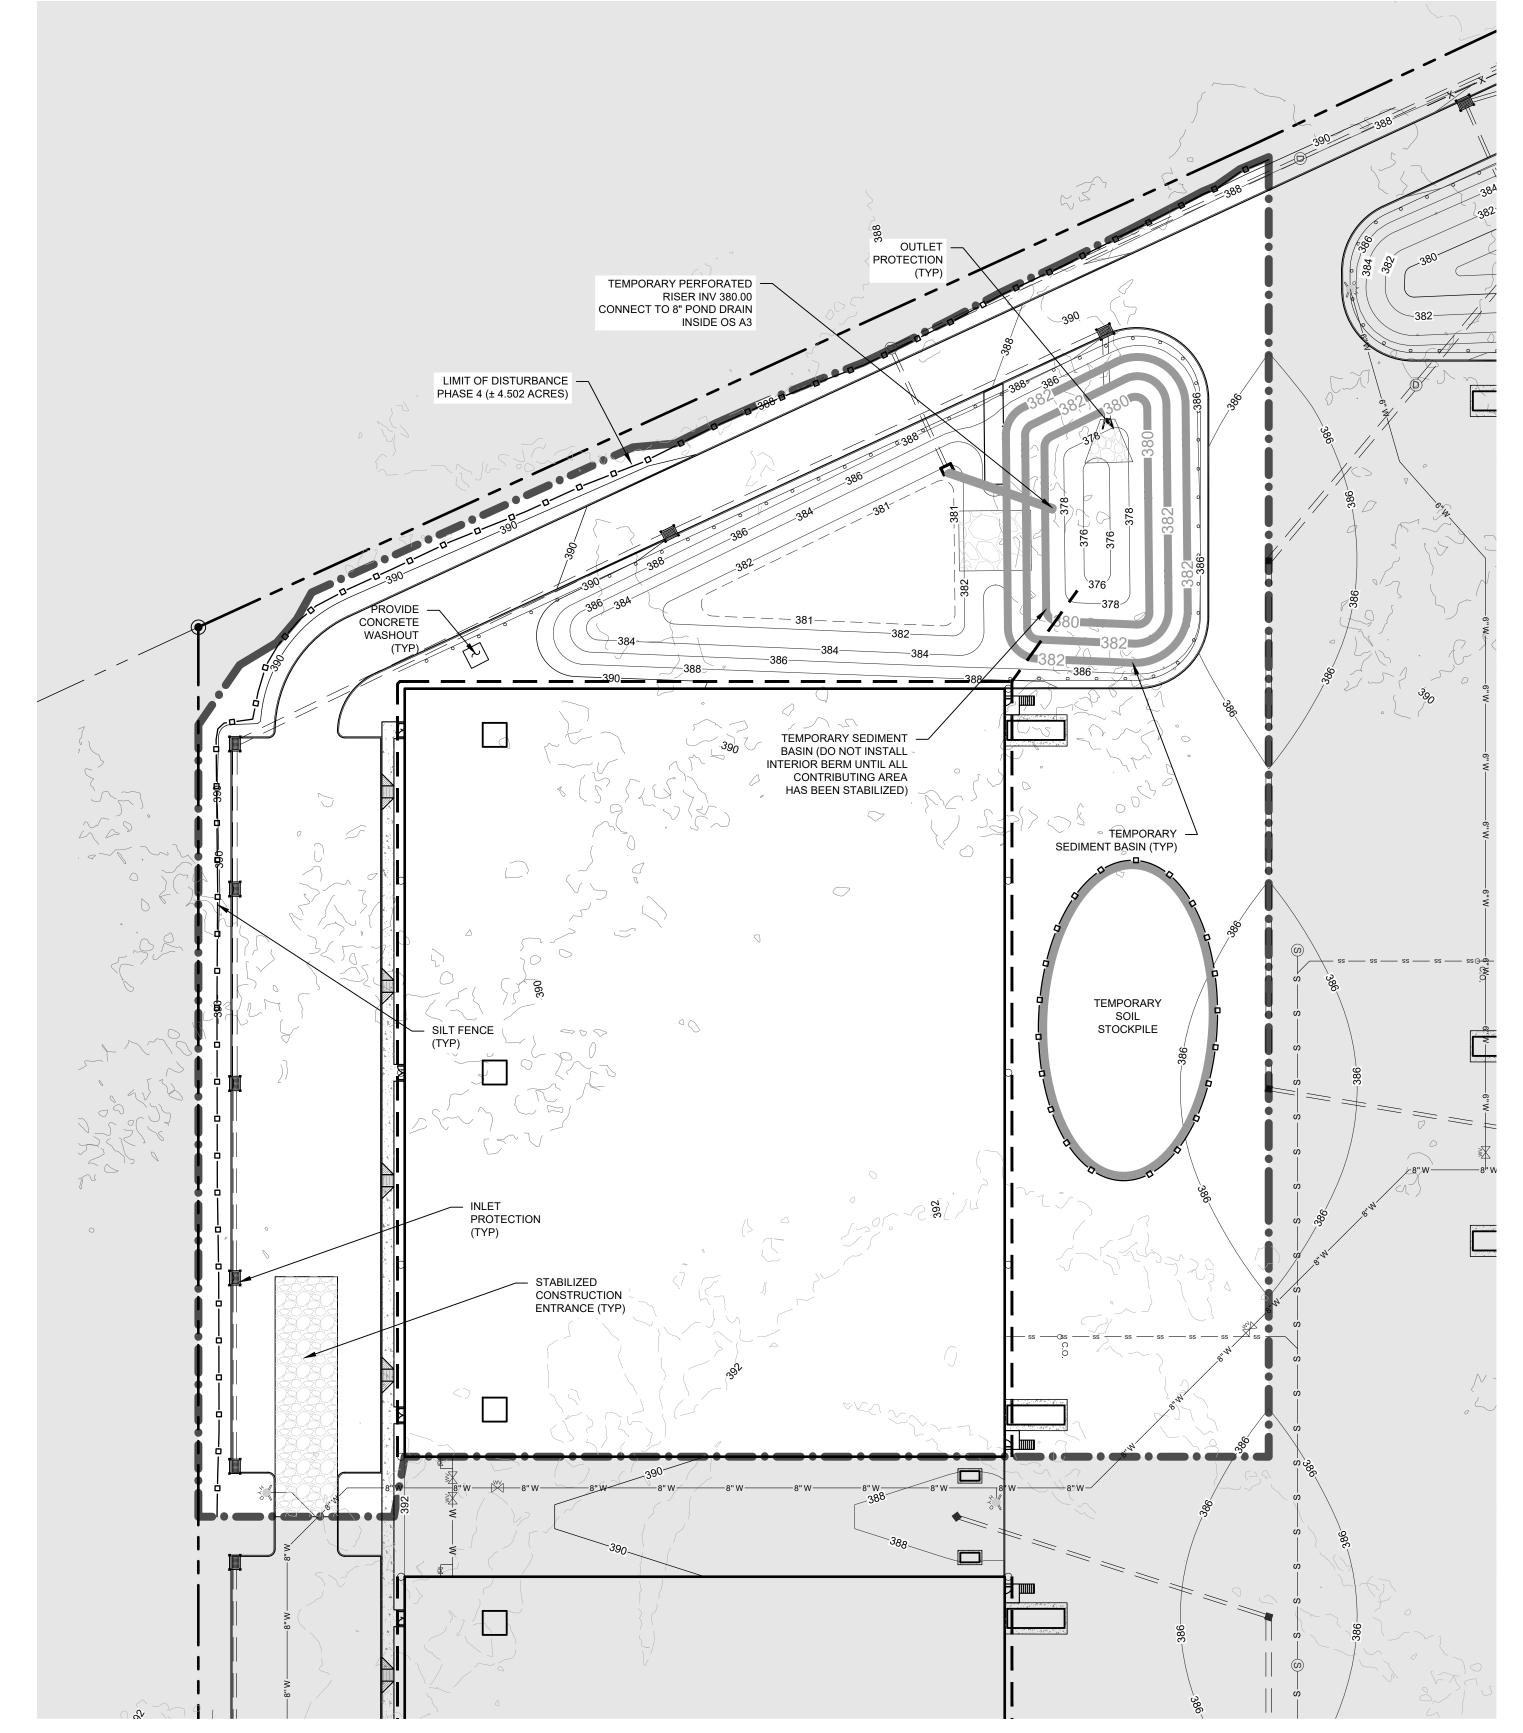

PHASE 4 EROSION & SEDIMENT CONTROL PLAN

SCALE: 1" = 40'

NOTES:

1. TO COMPLETE THE EARTHWORK REQUIRED DURING SITE CONSTRUCTION DUE TO SIGNIFICANT SECTIONS OF CUT AND FILL AREAS REQUIRED FOR BUILDINGS OF THIS SIZE, A WAIVER FROM THE


NYSDEC 5 ACRE MAXIMUM DISTURBANCE WILL BE REQUESTED.


- 2. ANY SITE WORK PERFORMED DURING THE "WINTER MONTHS" WHICH CONSIST OF NOVEMBER 15 THRU APRIL 1, SHALL COMPLY WITH ALL ADDITIONAL MEASURES NOTED ON THIS PLAN REFERRING TO WINTER MONTHS, ALL EROSION & SEDIMENT CONTROL NOTES LOCATED ON THE DETAIL SHEETS WITHIN THIS PLAN SET, AND THE NYS STANDARDS AND SPECIFICATIONS FOR EROSION AND SEDIMENT CONTROL, SPECIFICALLY PAGE 2.38.
- 3. THE OWNER OR OPERATOR SHALL HAVE A QUALIFIED INSPECTOR CONDUCT AT LEAST TWO (2) SITE INSPECTIONS IN ACCORDANCE WITH PART IV.C. OF THIS PERMIT EVERY SEVEN (7) CALENDAR DAYS, FOR AS LONG AS GREATER THAN FIVE (5) ACRES OF SOIL REMAIN DISTURBED. THE TWO (2) INSPECTIONS SHALL BE SEPARATED BY A MINIMUM OF TWO (2) FULL CALENDAR DAYS.
- 4. IN AREAS WHERE SOIL DISTURBANCE ACTIVITY HAS TEMPORARY OR PERMANENTLY CEASED, THE APPLICATION OF SOIL STABILIZATION MEASURES MUST BE INITIATED BY THE END OF THE NEXT BUSINESS DAY AND COMPLETED WITHIN SEVEN (7) DAYS FROM THE DATE THE CURRENT SOIL DISTURBANCE ACTIVITY CEASED. THE SOIL STABILIZATION MEASURES SELECTED SHALL BE IN CONFORMANCE WITH THE TECHNICAL STANDARD, NEW YORK STATE STANDARDS AND SPECIFICATIONS FOR EROSION AND SEDIMENT CONTROL, DATED NOVEMBER 2016.





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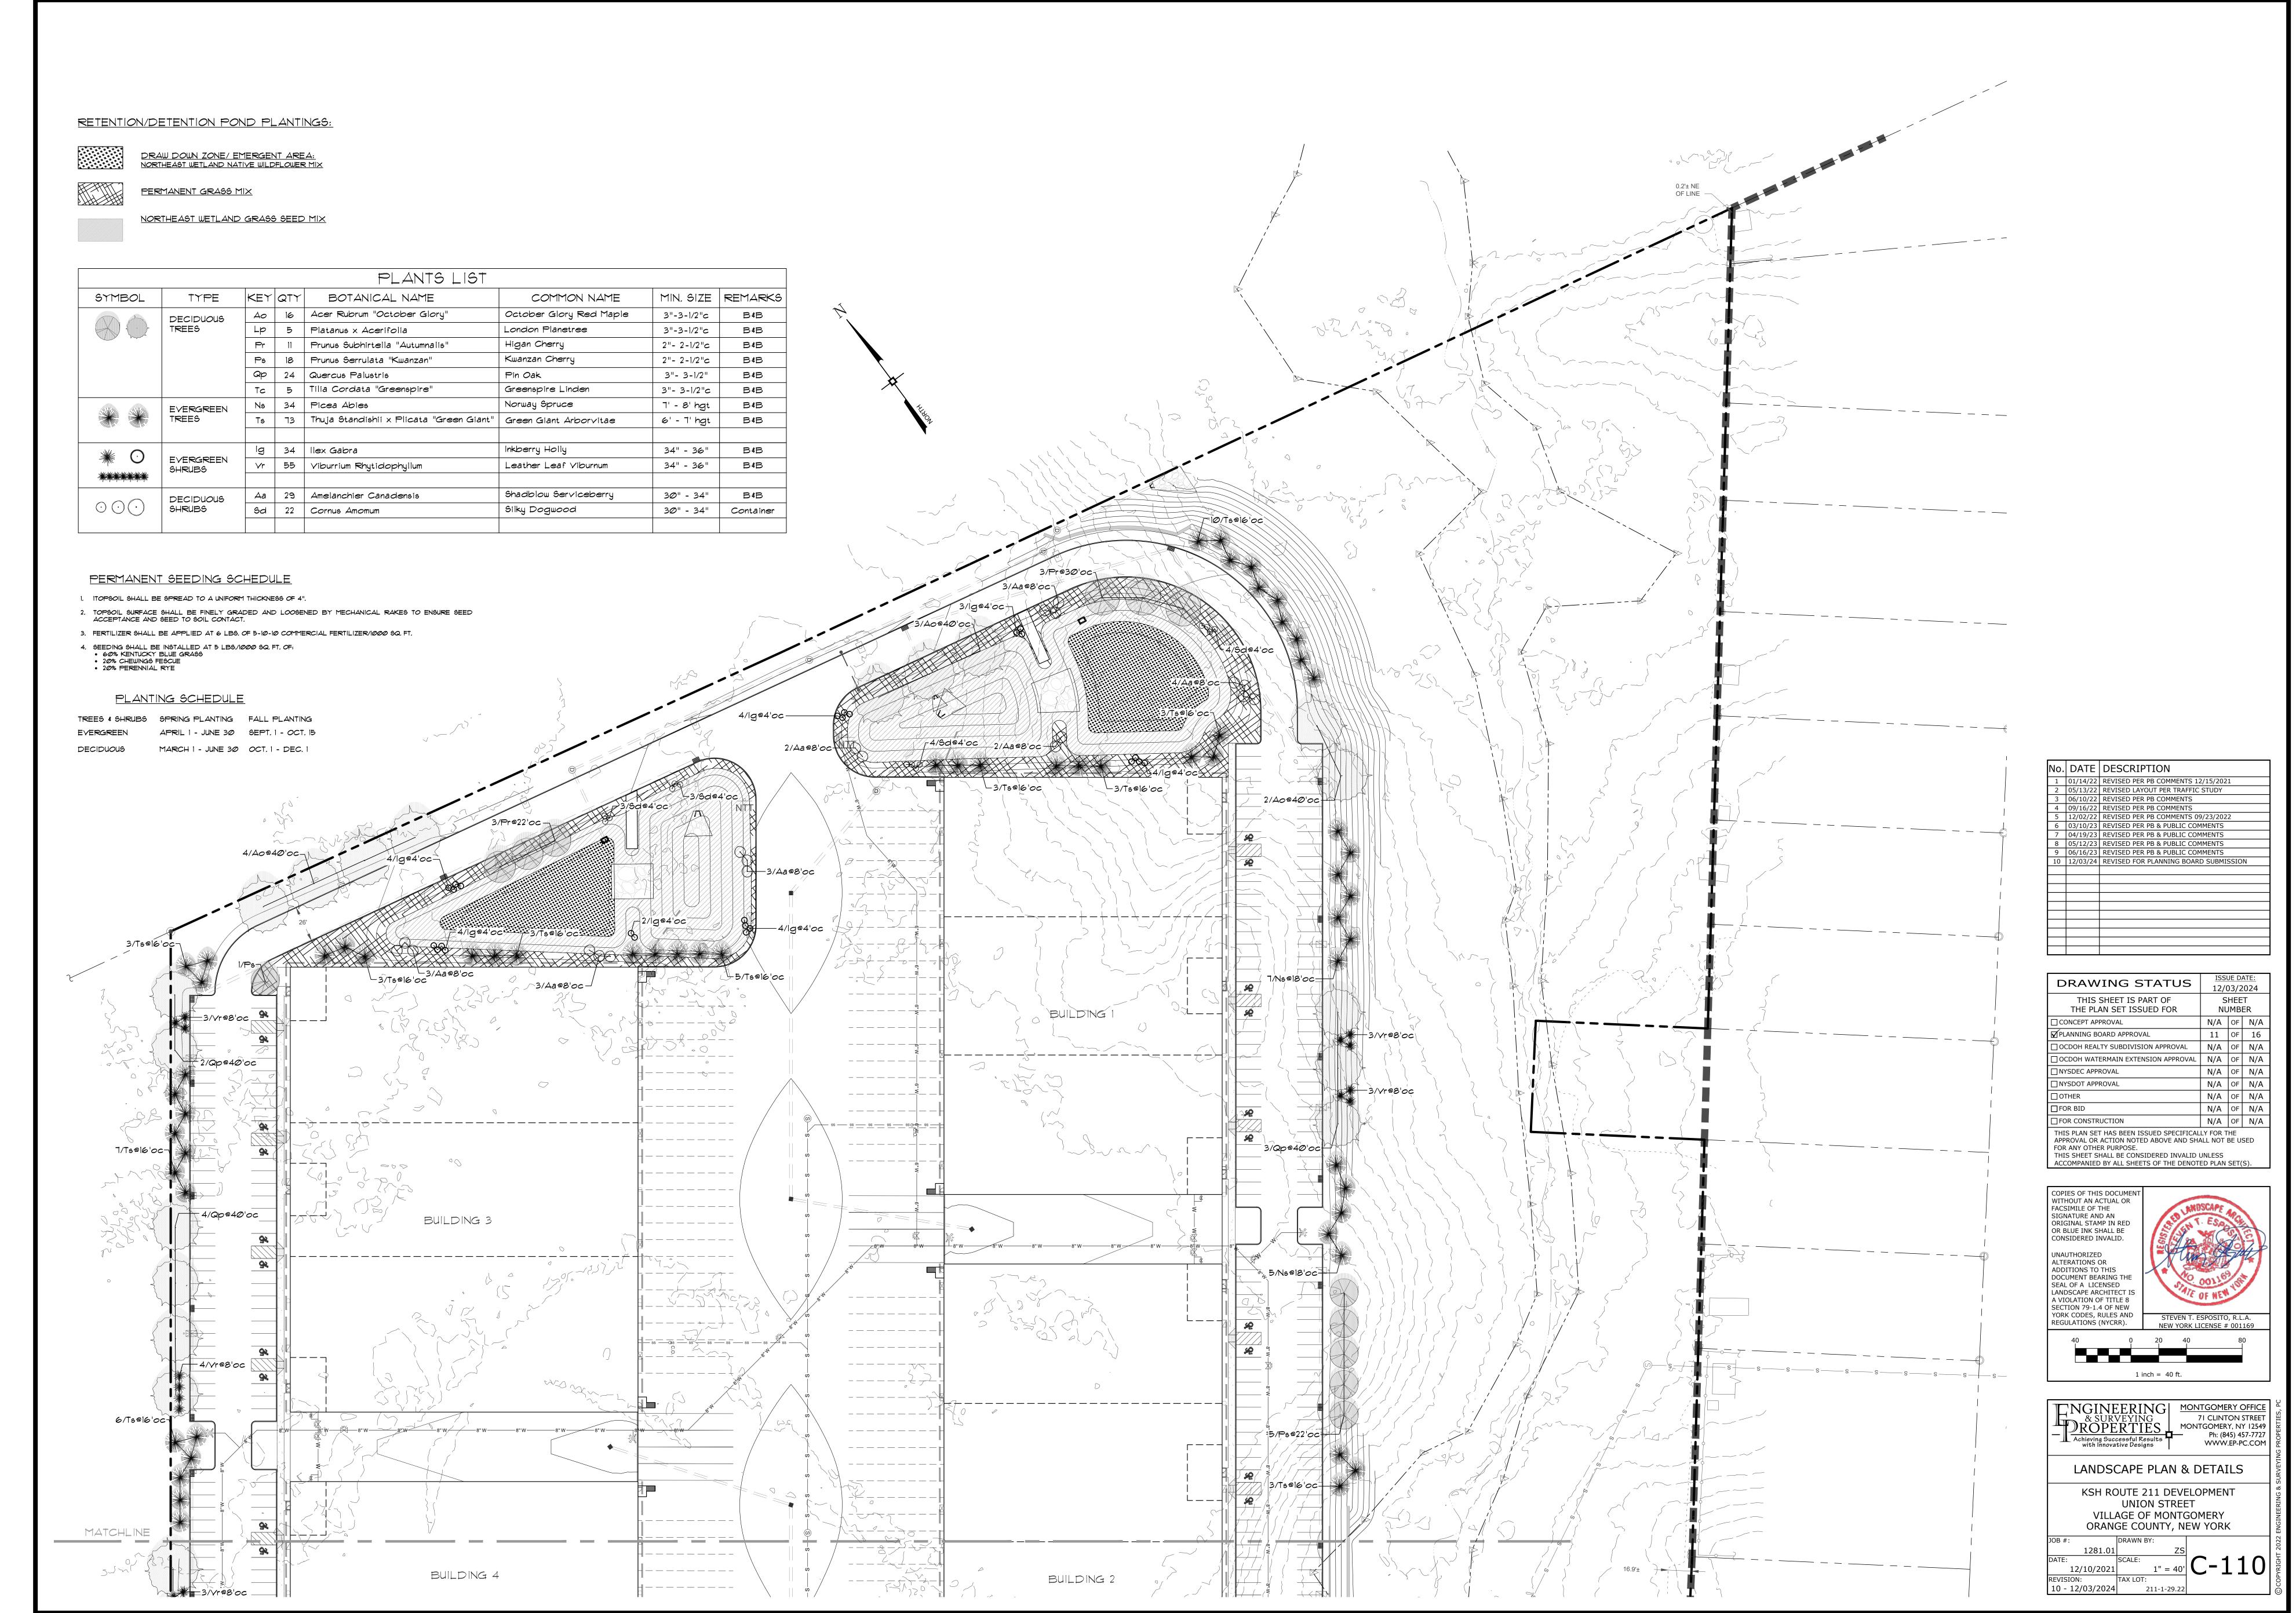
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DRAWING STATUS	ISSUE DATE: 12/03/2024			
THIS SHEET IS PART OF THE PLAN SET ISSUED FOR	S	HEE JMBI	Т	
☐ CONCEPT APPROVAL	N/A	OF	N/A	
☑ PLANNING BOARD APPROVAL	8	OF	16	
OCDOH REALTY SUBDIVISION APPROVAL	N/A	OF	N/A	
OCDOH WATERMAIN EXTENSION APPROVAL	N/A	OF	N/A	
□ NYSDEC APPROVAL	N/A	OF	N/A	
□ NYSDOT APPROVAL	N/A	OF	N/A	
OTHER	N/A	OF	N/A	
☐FOR BID	N/A	OF	N/A	
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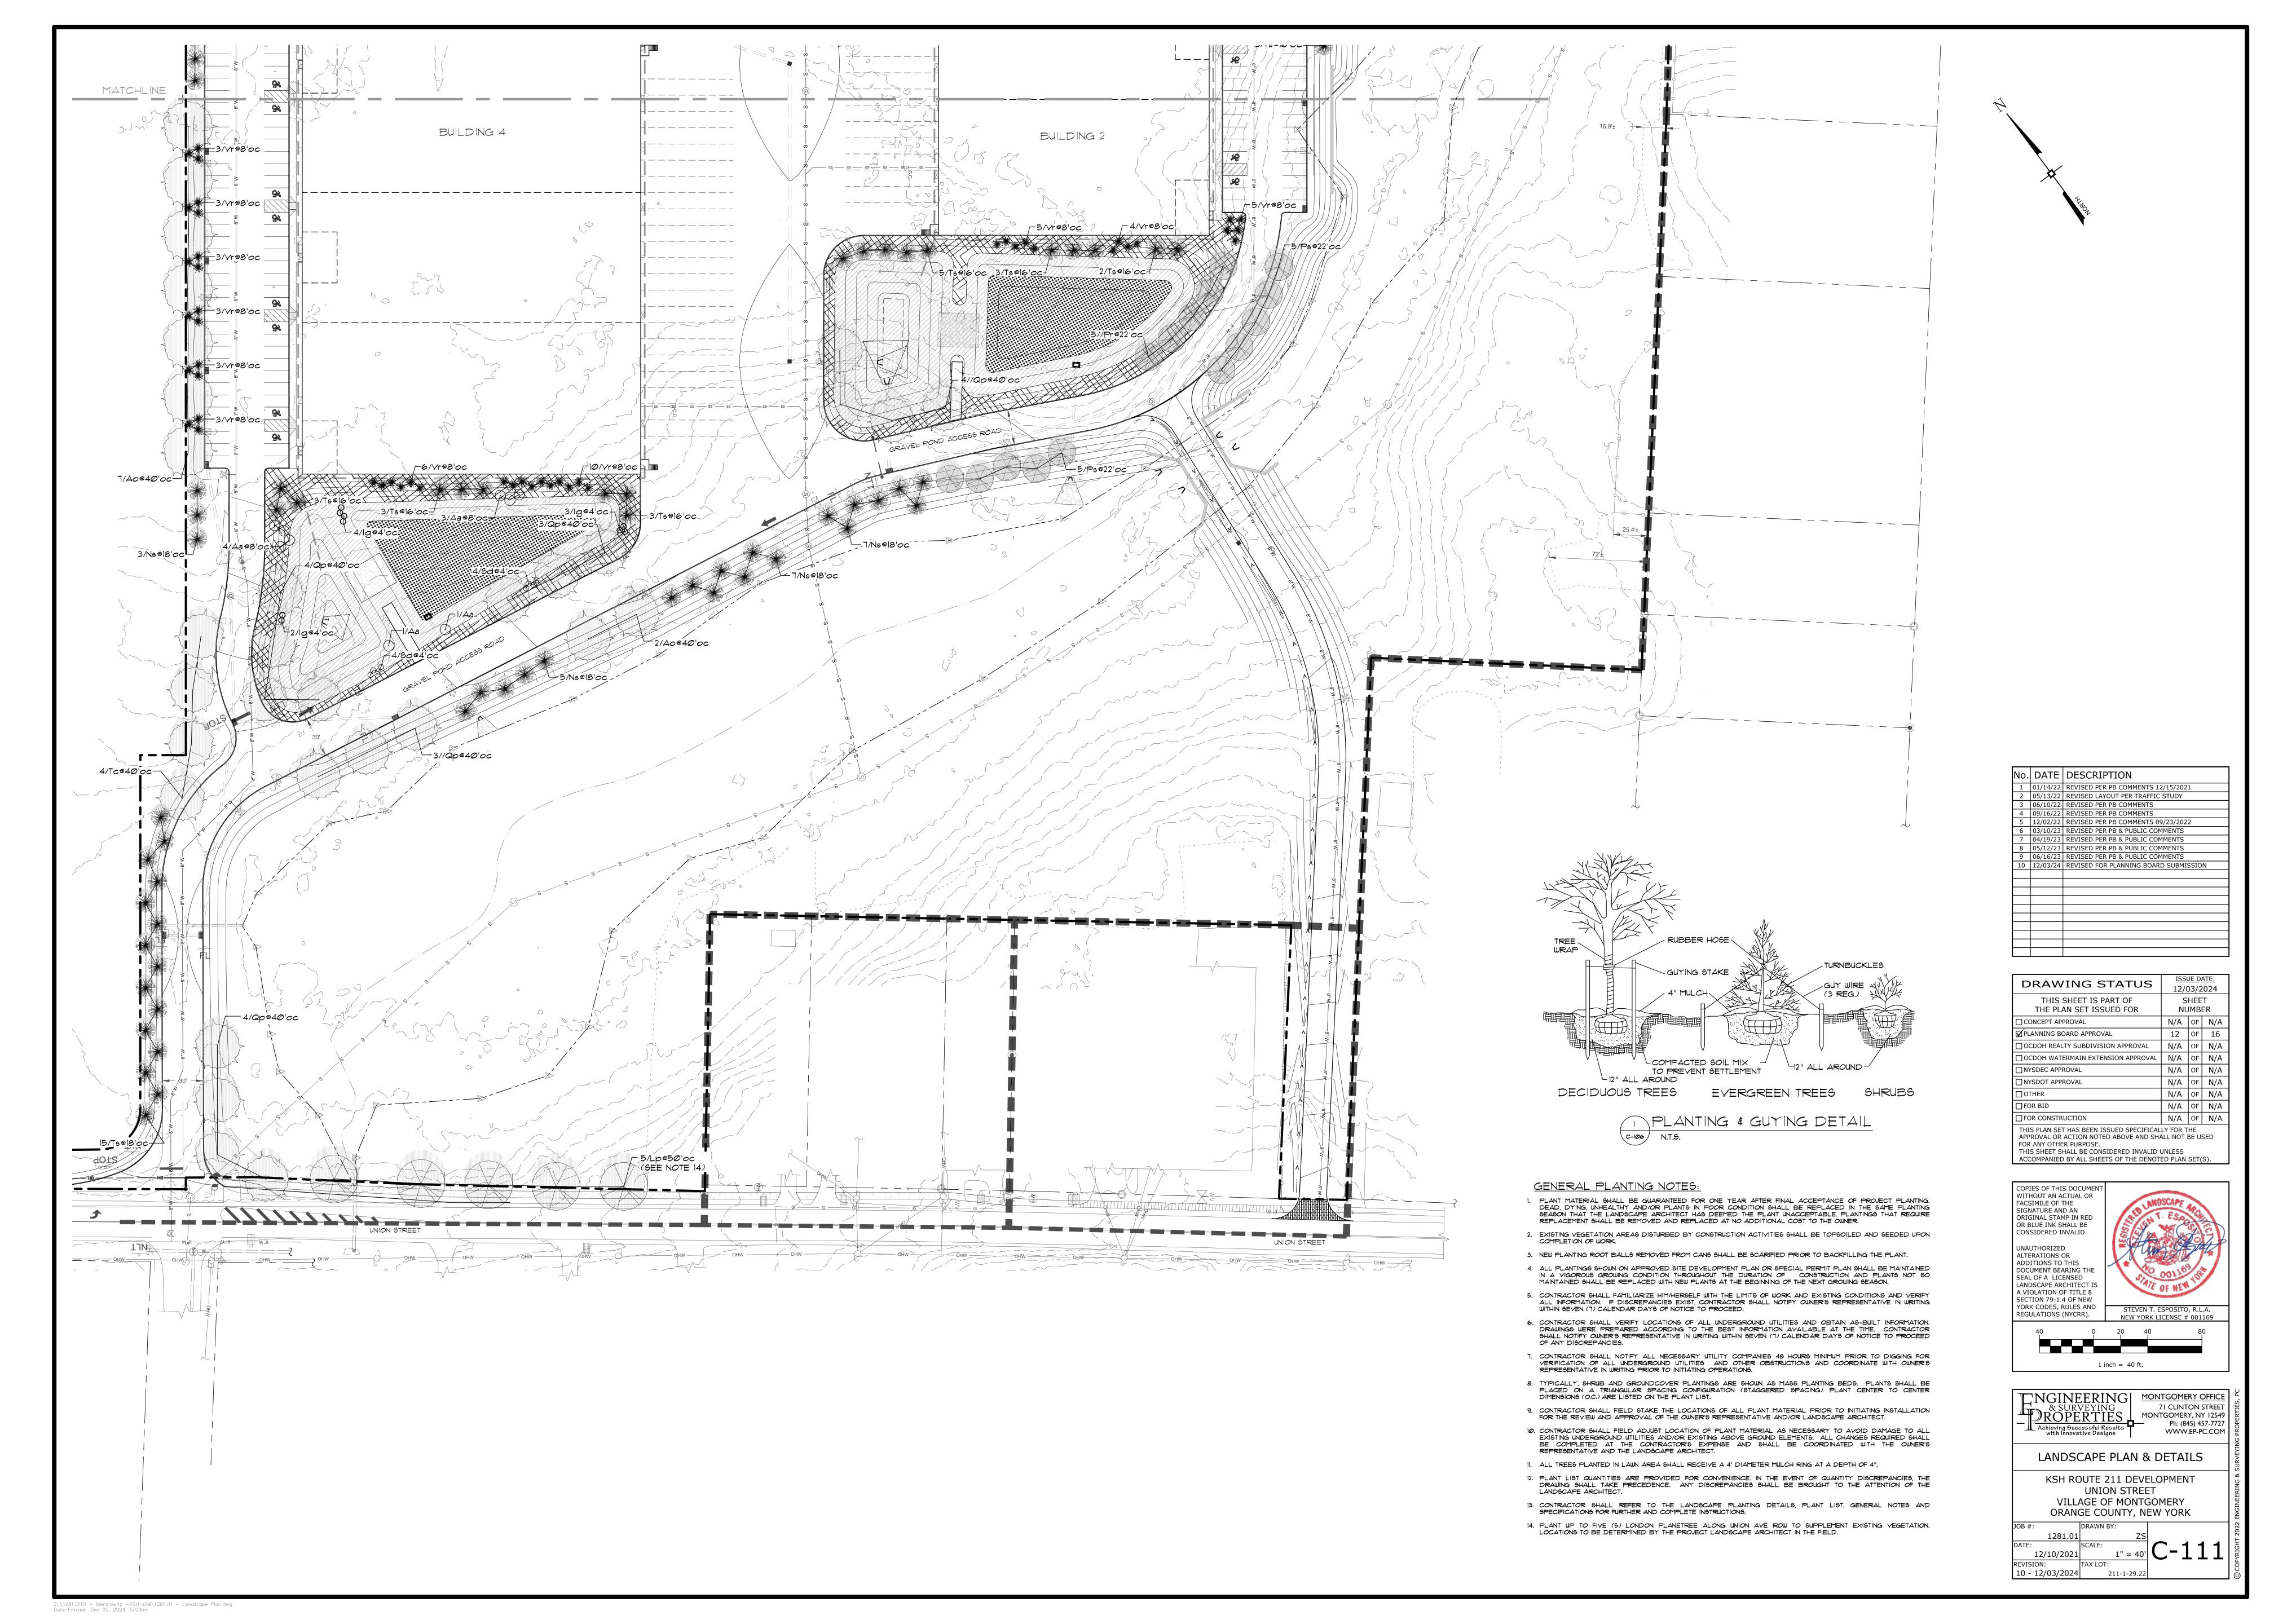





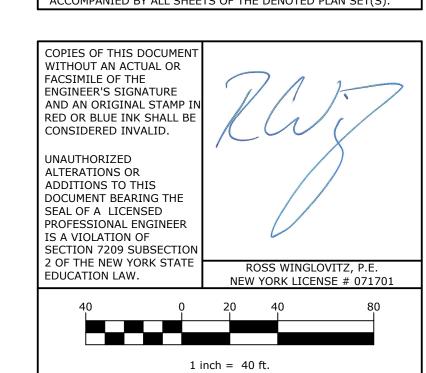


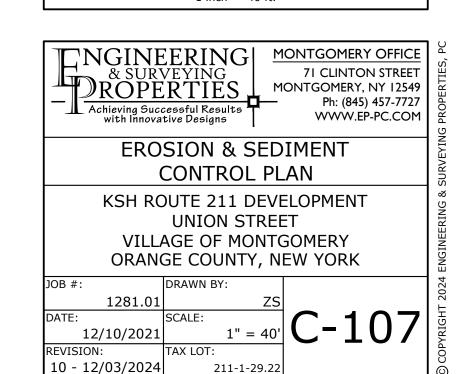

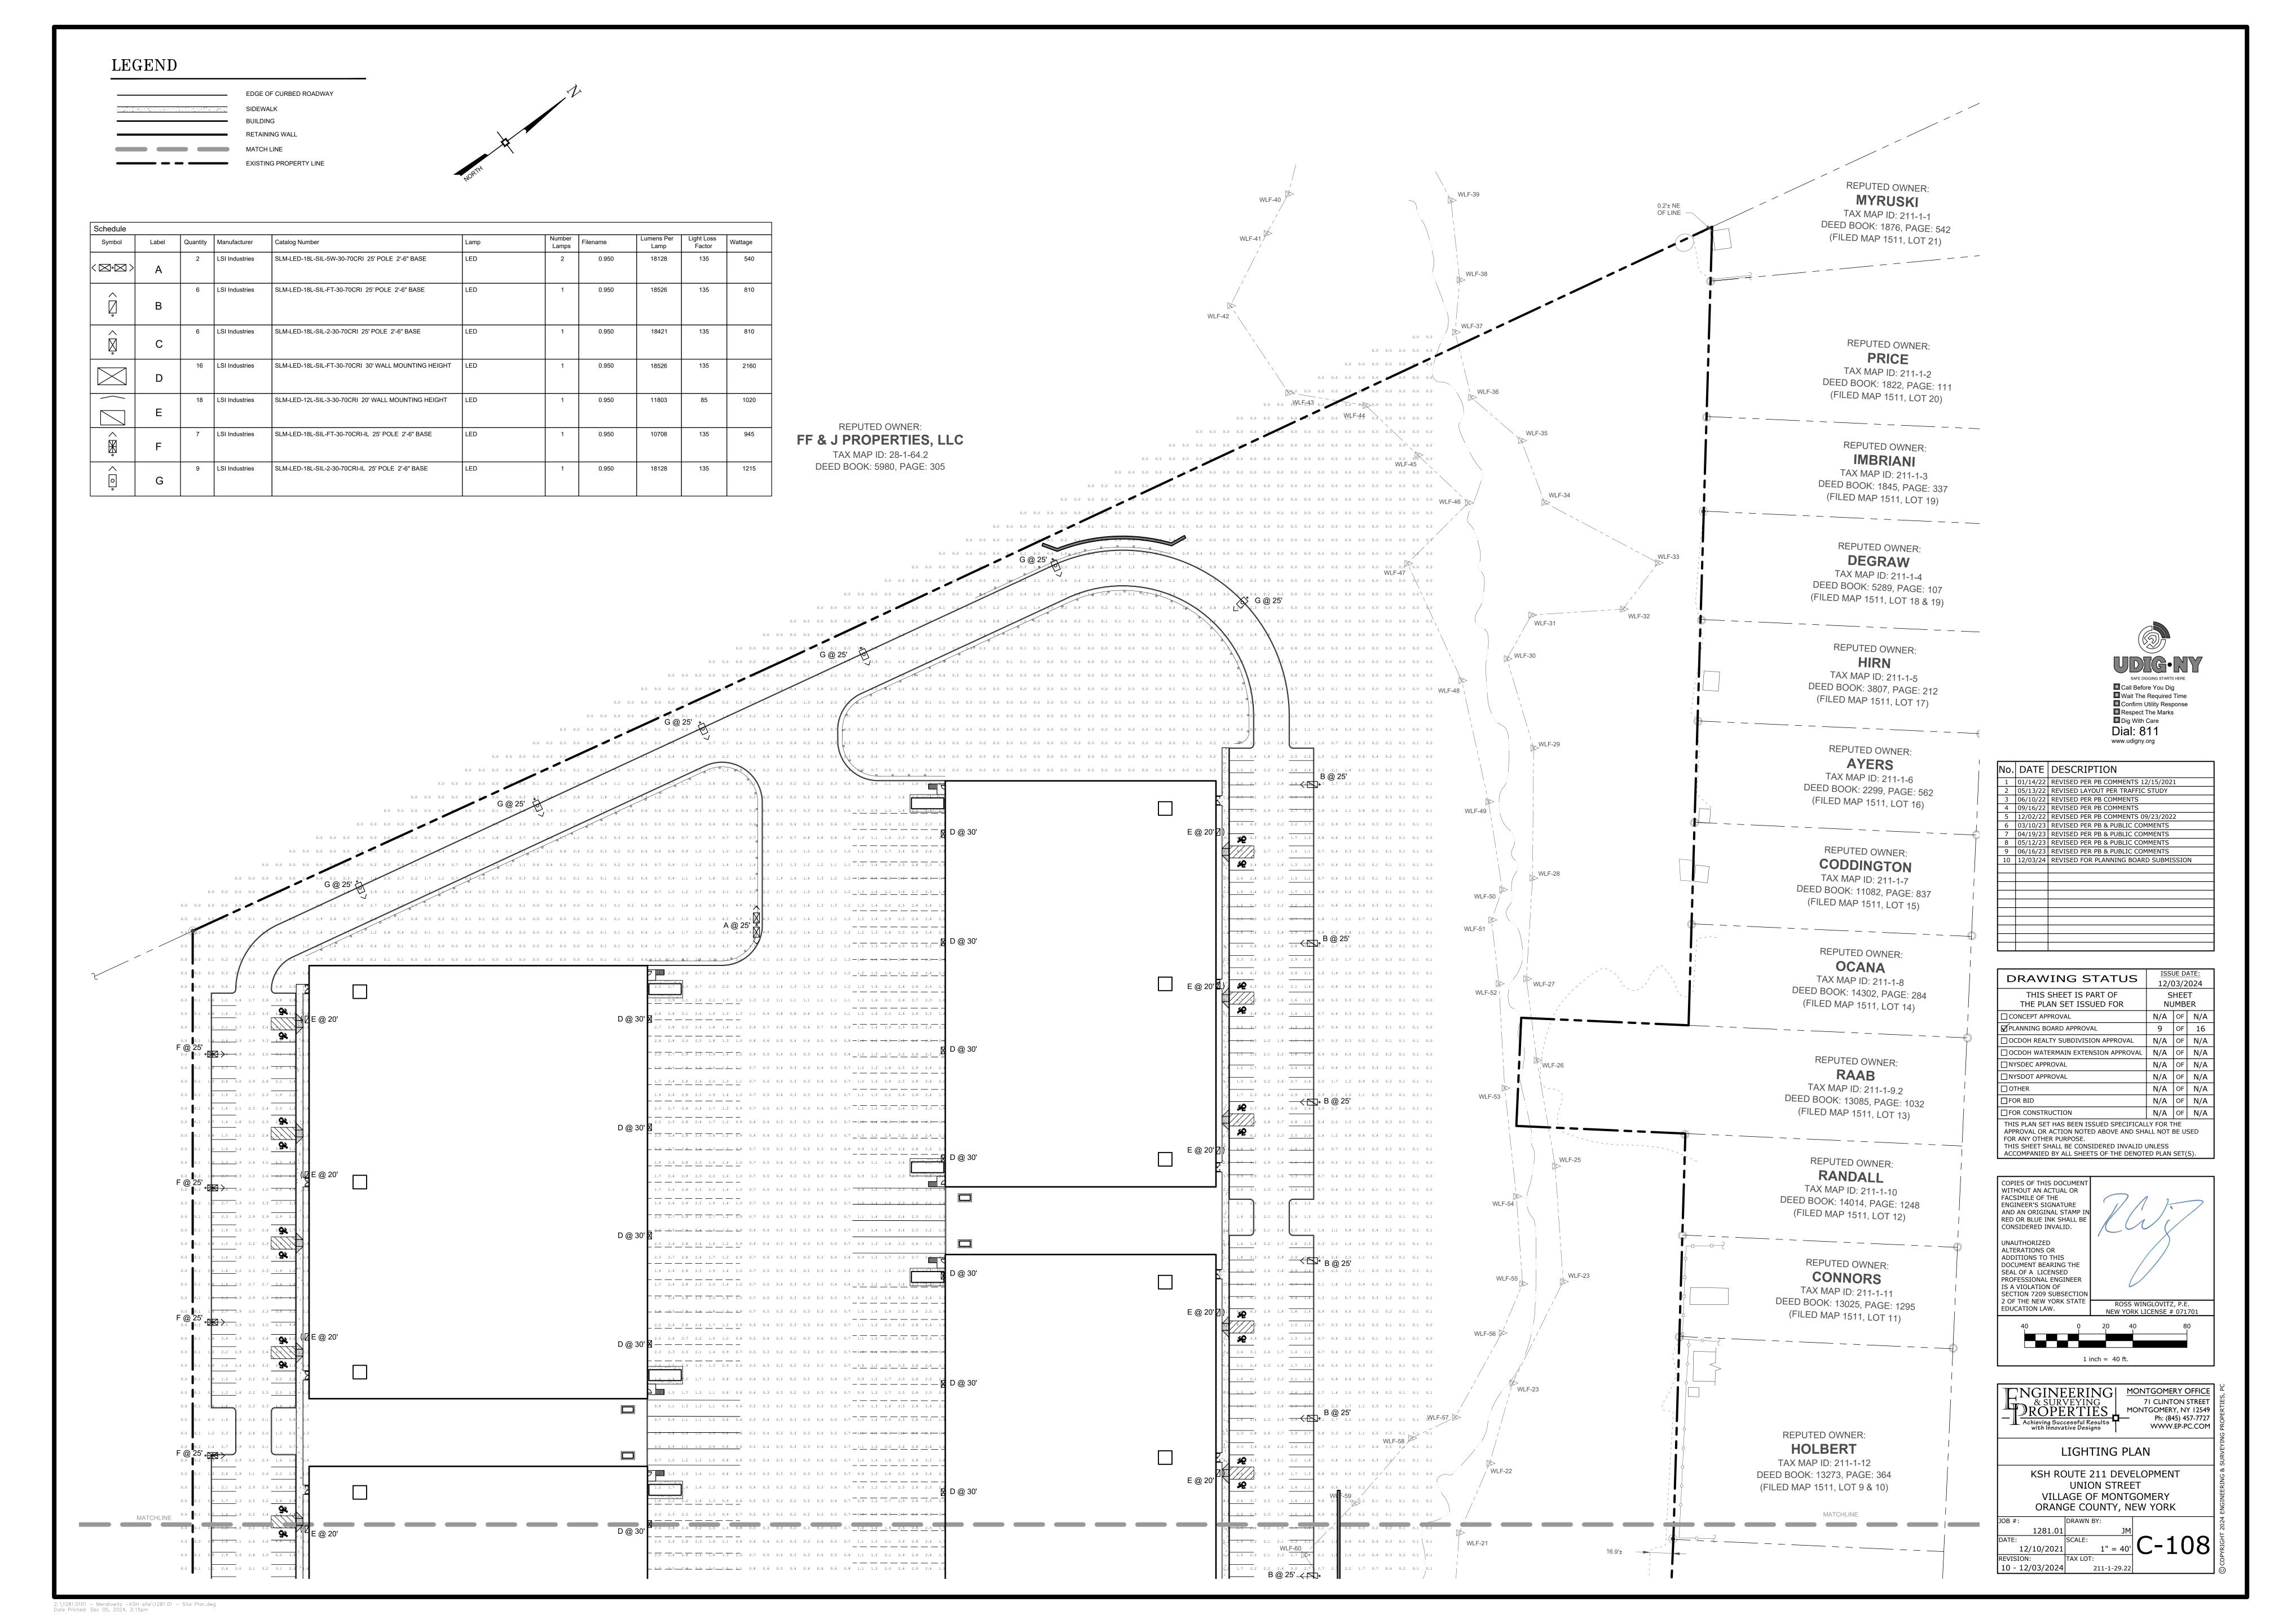


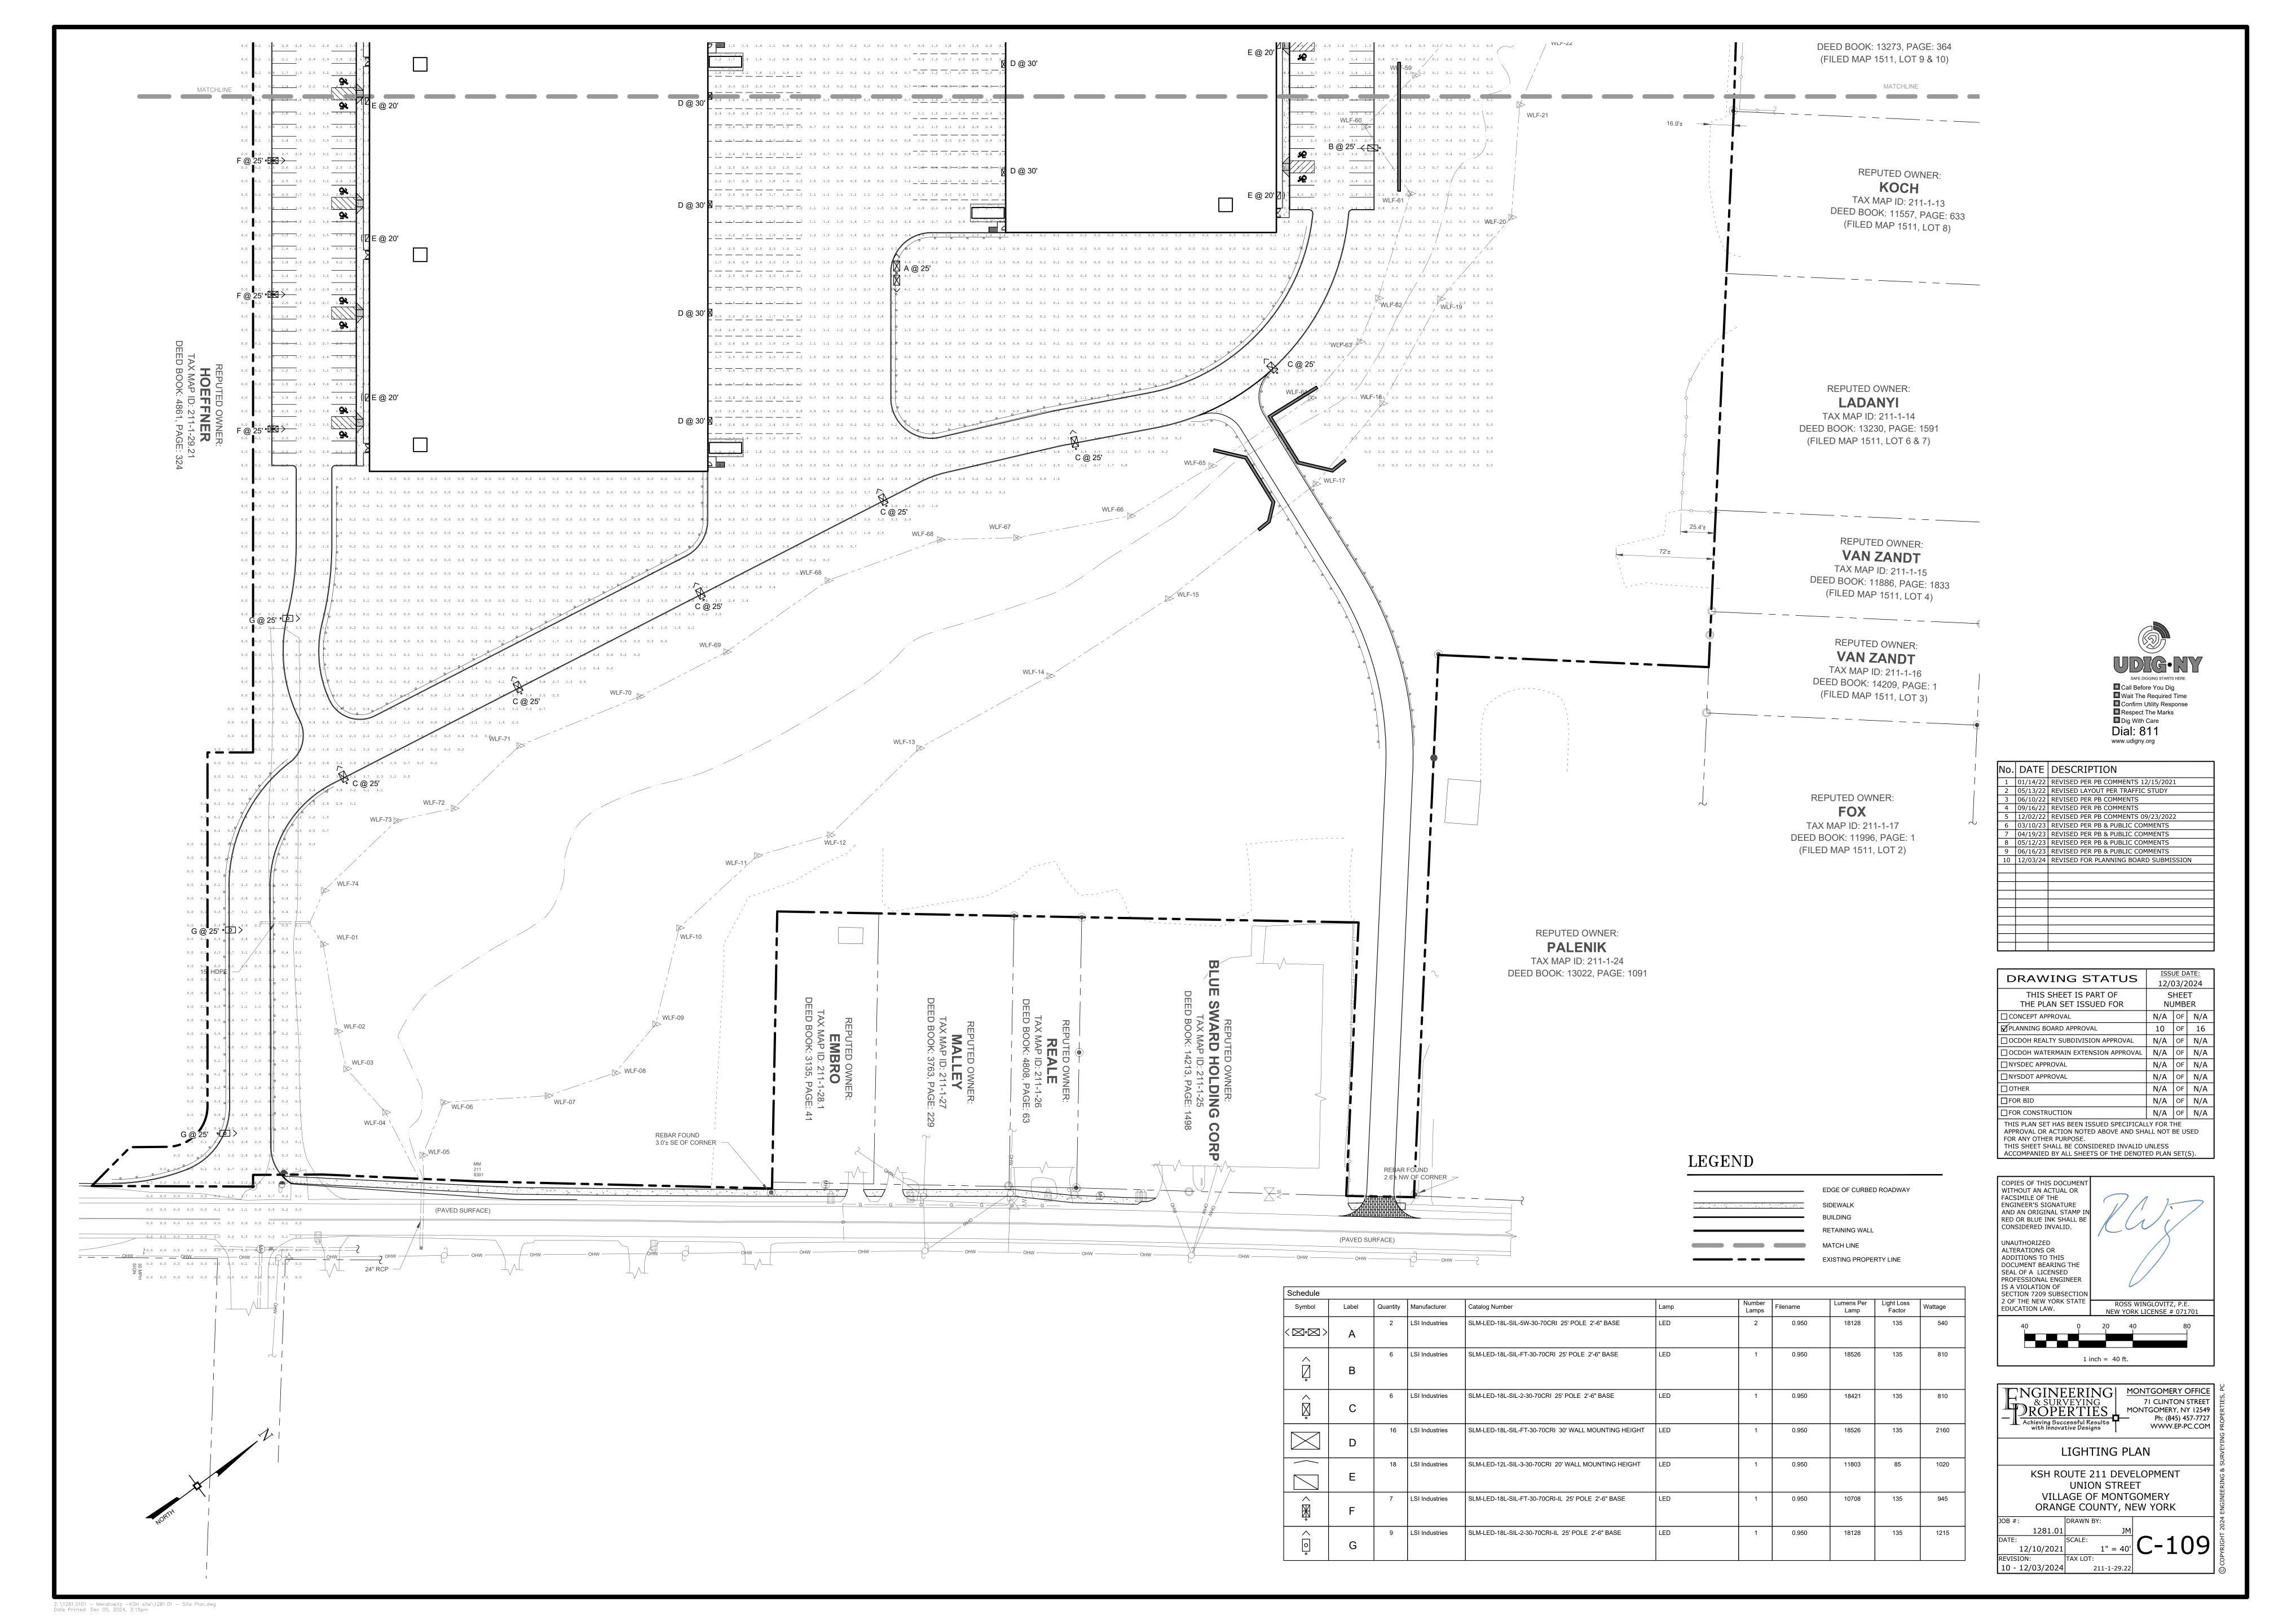

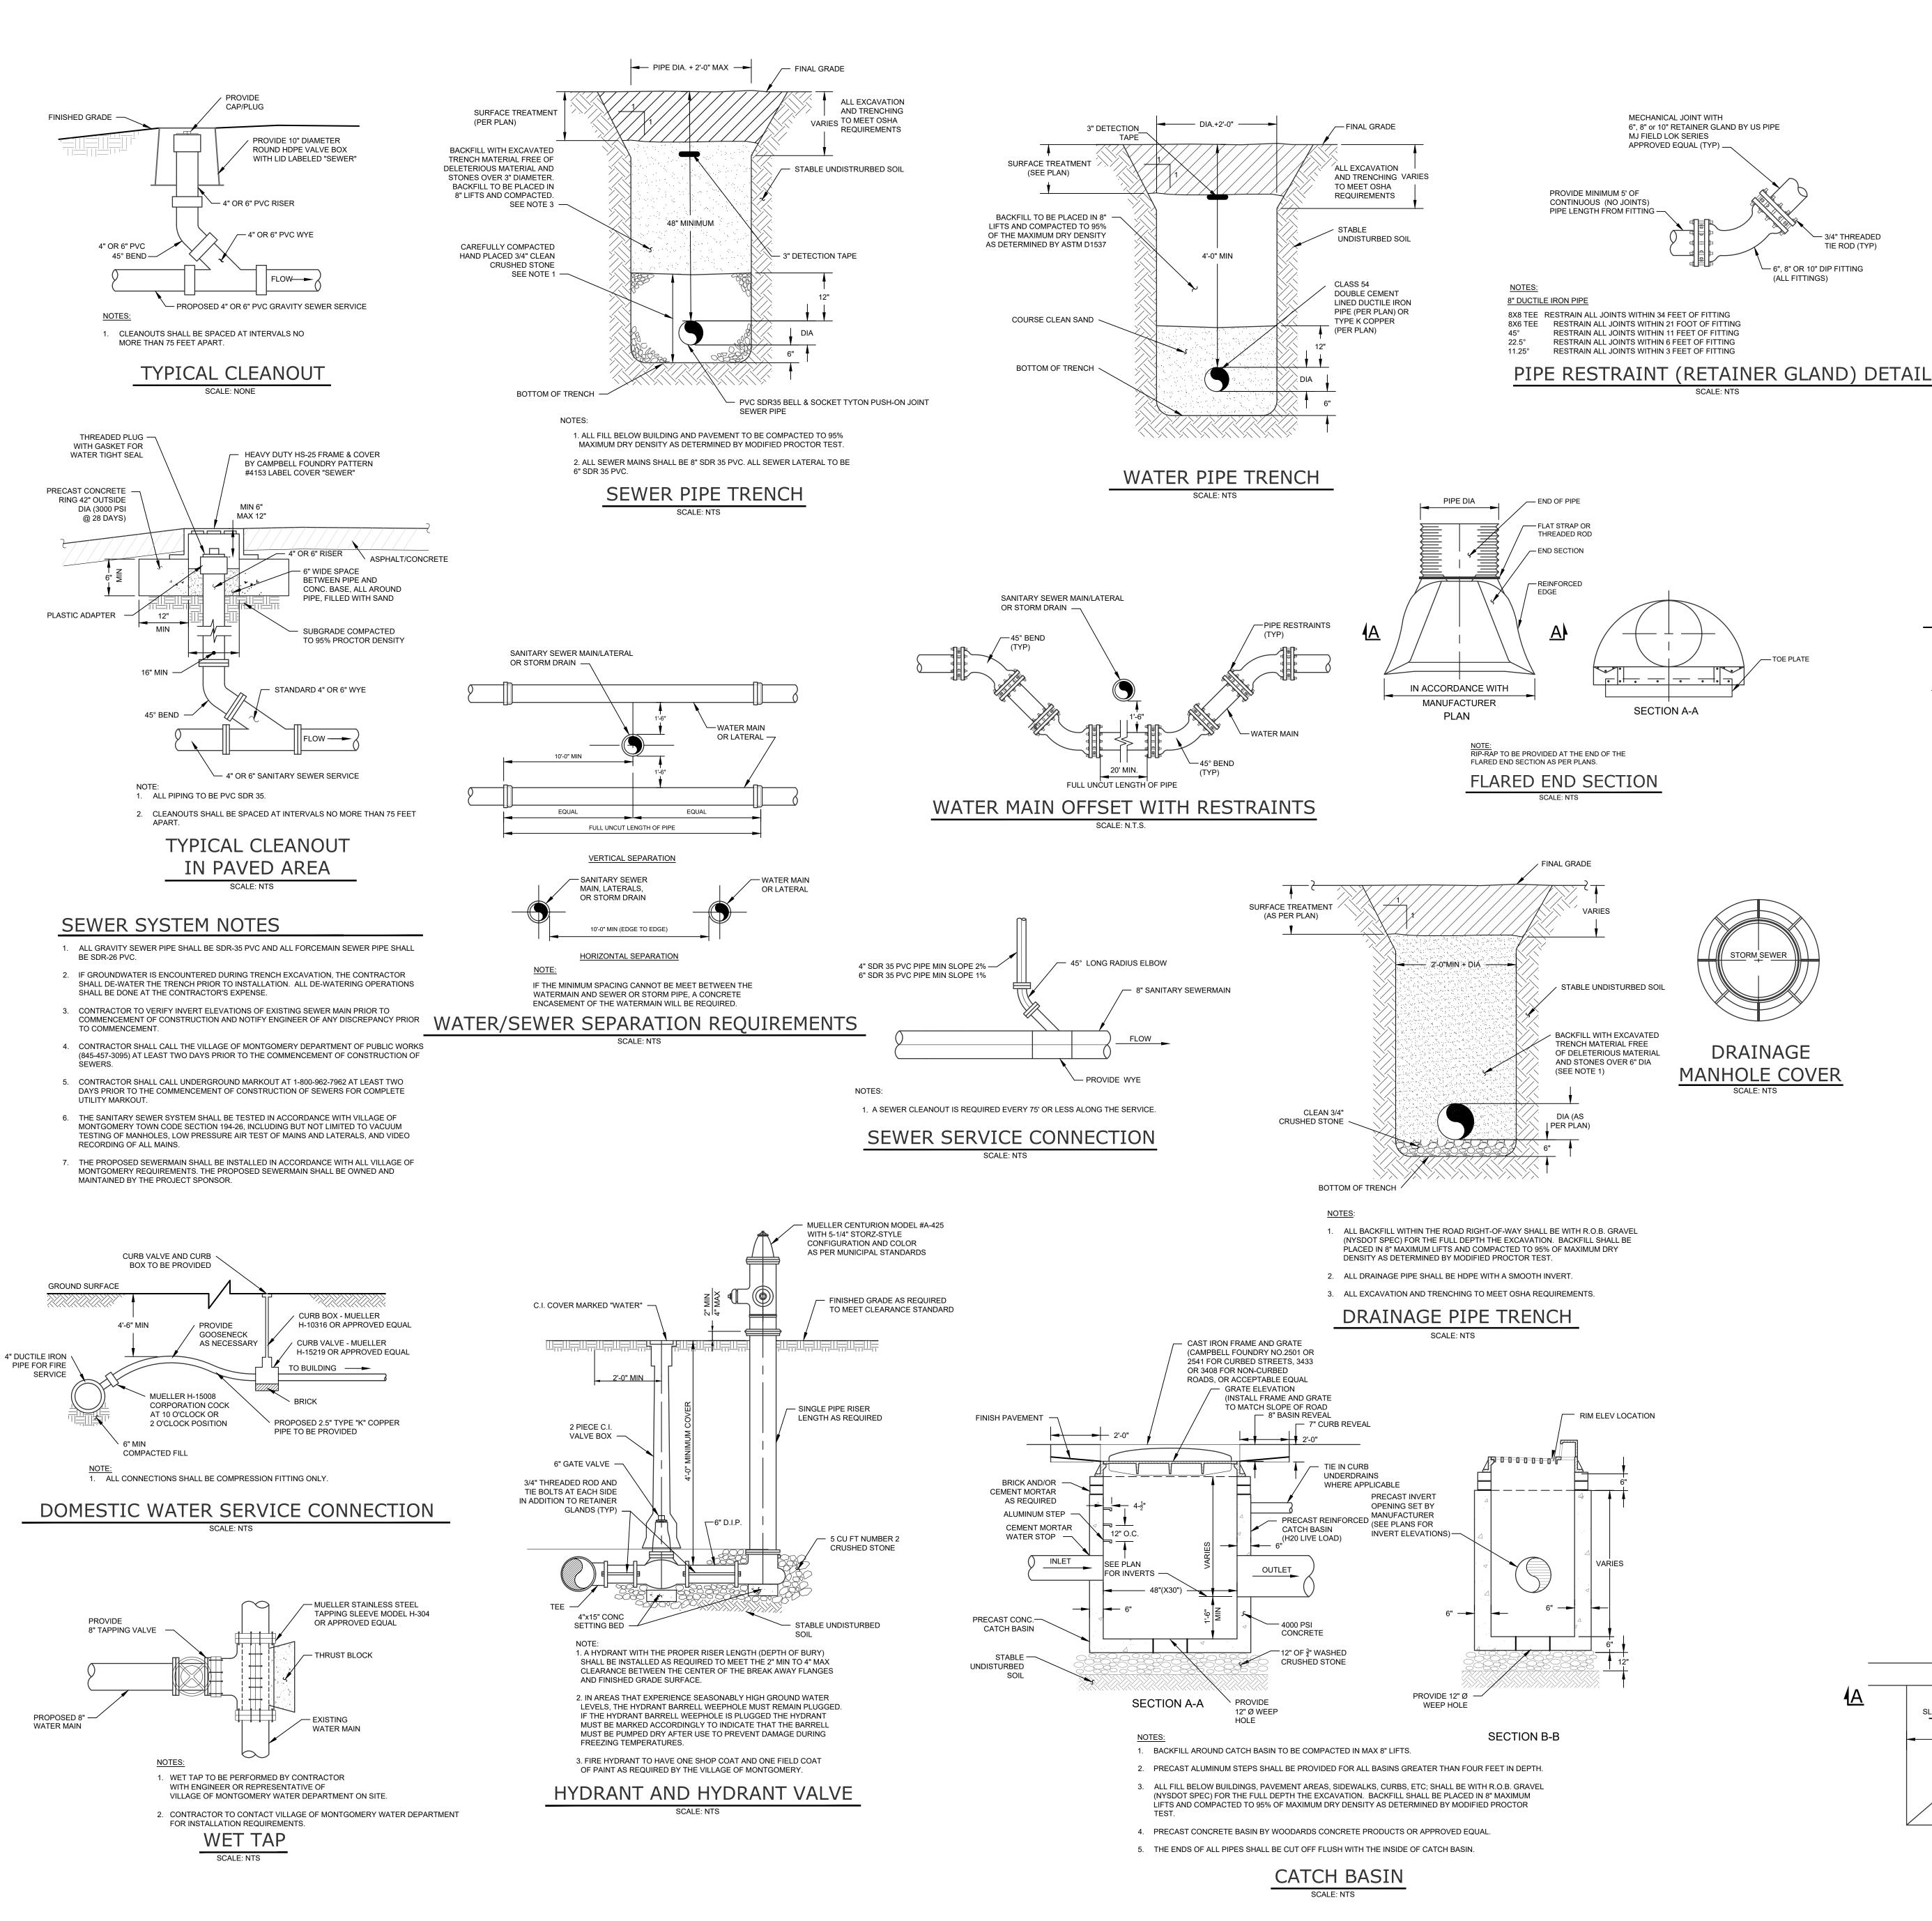

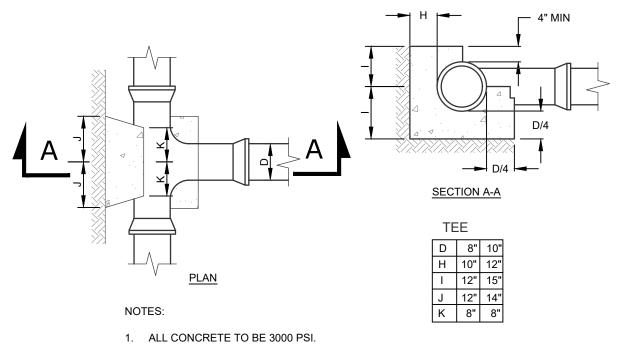

- 2. ALL THRUST BLOCKS TO BE CARRIED TO UNDISTURBED EARTH. 3. THRUST BLOCK DIMENSIONS SHOWN ARE MINIMUM.
- 4. ALL FITTINGS ARE TO INCLUDE THRUST BLOCKS AND RETAINER GLANDS.

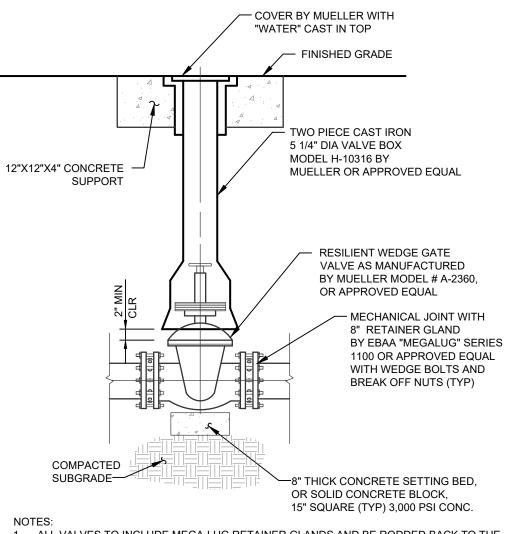

1. ALL VALVES TO INCLUDE MEGA-LUG RETAINER GLANDS AND BE RODDED BACK TO THE ADJACENT TEE IN THE WATERMAIN. INLINE VALVES NEED NOT BE RODDED. CONTRACTOR TO UTILIZE  $\frac{3}{4}$ " DIA. GALVANIZED STEEL RODS WITH MALLEABLE IRON NUTS

2. WATERMAIN VALVES FOR FOUR INCH THROUGH FORTY EIGHT INCH SHALL BE RESILIENT WEDGE GATE VALVES AS MANUFACTURED BY MUELLER, MODEL #A-2360. VALVES SHALL BE PROVIDED WITH AN EXTENSION SERVICE BOX TO GRADE.

3. MAIN LINE VALVES TO BE SPACED TO NO FURTHER THAN 500 FEET APART IN COMMERCIAL DISTRICTS AND 800 FEET IN OTHER DISTRICTS.

# WATER SYSTEM NOTES


- 1. CONTRACTOR SHALL VERIFY THE LOCATION AND ELEVATION OF EXISTING WATER AND SEWER UTILITIES PRIOR TO THE COMMENCEMENT OF CONSTRUCTION.
- 2. CONTRACTOR TO CALL UNDERGROUND MARK-OUT AT LEAST 2 DAYS PRIOR TO COMMENCEMENT OF CONSTRUCTION AT 1-800-962-7962 FOR COMPLETE UTILITIES MARKOUT.
- 3. CONTRACTOR TO CONTACT VILLAGE OF MONTGOMERY DEPARTMENT OF PUBLIC WORKS AT
- LEAST 2 DAYS PRIOR TO CONSTRUCTION. 4. WATER MAIN 4" OR LARGER TO BE CLASS 54 BITUMINOUS COATED DOUBLE CEMENT LINED
- DUCTILE IRON PIPE.
- 5. CONTRACTOR TO NOTIFY ENGINEER IMMEDIATELY OF ANY DEVIATION FROM HORIZONTAL OR VERTICAL ALIGNMENTS WITH REGARDS TO EXISTING UTILITIES BEFORE PROCEEDING.

6. A CERTIFIED AS BUILT MAP OF THE WATER SYSTEM IMPROVEMENTS SHALL BE PROVIDED TO

CONSTRUCTION IN ACCORDANCE WITH THE INSURANCE SERVICES OFFICE (ISO) GUIDELINES,


PER THE RECOMMENDED STANDARDS FOR WATER WORKS (NYS SANITY CODE PART 5.

- THE VILLAGE OF MONTGOMERY WATER DEPARTMENT BY A LICENSED DESIGN PROFESSIONAL 7. THIS PROJECT HAS DEMONSTRATED AN AVAILABLE FLOW OF 2,076 GALLONS PER MINUTE WHILE MAINTAINING A MINIMUM OF 20 PSI AT ALL POINTS IN THE DISTRIBUTION SYSTEM. THIS VALUE SHOULD BE COMPARED TO THE NEEDED FIRE FLOW (NFF) FOR THE PROPOSED
- APPENDIX 5-A). THE NEEDED FIRE FLOW FOR THE PROPOSED CONSTRUCTION IS 500 GPM AAS PER ISO GUIDELINES. 8. ALL PIPE, FIXTURES AND FITTINGS MUST COMPLY WITH THE FEDERAL "SAFE DRINKING WATER ACT". SECTION 1417 WHICH REQUIRES ALL SURFACES IN CONTACT WITH POTABLE WATER
- 9. THE VILLAGE OF MONTGOMERY COMMISSIONER OF PUBLIC WORKS OR HIS DESIGNATED REPRESENTATIVE MUST BE INFORMED OF ANY HYDROSTATIC OR BACTERIOLOGICAL TESTING
- TO PERMIT THE TESTING TO BE WITNESSED.
- 10. THE VILLAGE OF MONTGOMERY COMMISSIONER OR PUBLIC WORKS OR HIS DESIGNATED REPRESENTATIVE MUST ACCEPT HYDROSTATIC AND BACTERIOLOGICAL TEST RESULTS AS
- 11. THE PROPOSED WATERMAIN SHALL BE INSTALLED IN ACCORDANCE WITH ALL VILLAGE OF MONTGOMERY REQUIREMENTS. THE PROPOSED WATERMAIN SHALL BE OWNED AND MAINTAINED BY THE PROJECT SPONSOR.

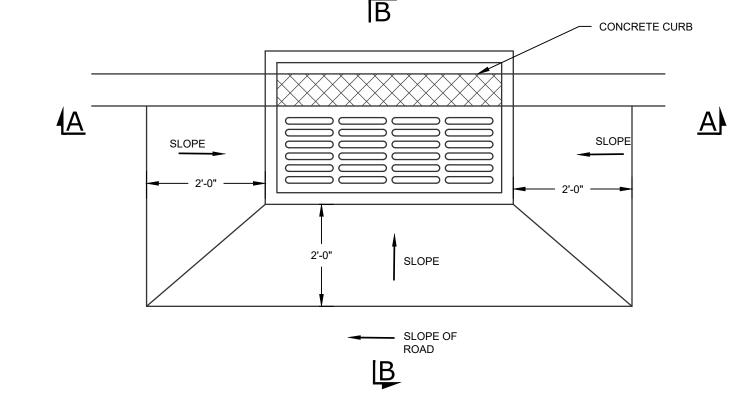

PLAN

CONTAIN NO MORE THAN 0.25% LEAD BY WEIGHT.

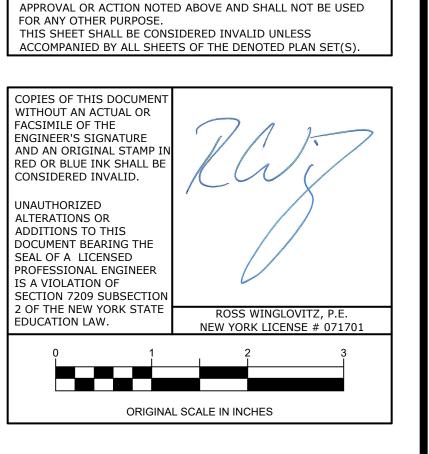

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REVISED PER PB COMMENTS 12/15/2021 2 REVISED LAYOUT PER TRAFFIC STUDY

2 REVISED PER PB COMMENTS 09/23/2022

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4 REVISED FOR PLANNING BOARD SUBMISSION

23 REVISED PER PB & PUBLIC COMMENTS

2 REVISED PER PB COMMENTS

2 REVISED PER PB COMMENTS

04/14/23 REVISED PER PB & PUBLIC COMMENTS

DRAWING STATUS

THIS SHEET IS PART OF THE PLAN SET ISSUED FOR

OCDOH REALTY SUBDIVISION APPROVAL

OCDOH WATERMAIN EXTENSION APPROVAL | N/A OF N/A

THIS PLAN SET HAS BEEN ISSUED SPECIFICALLY FOR THE

CONCEPT APPROVAL

NYSDEC APPROVAL

NYSDOT APPROVAL

FOR CONSTRUCTION

OTHER

PLANNING BOARD APPROVAL

6/16/23 REVISED PER PB & PUBLIC COMMENTS

No. DATE DESCRIPTION


■ Wait The Required Time

Confirm Utility Response


12/03/2024


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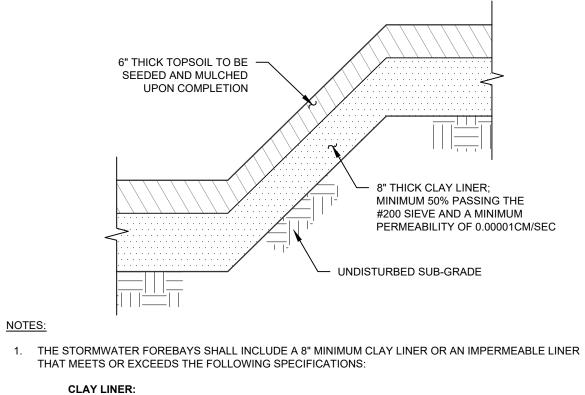


### 1. CONCRETE TO HAVE A MINIMUM COMPRESSIVE STRENGTH OF 4000 PSI AT 28 DAYS.

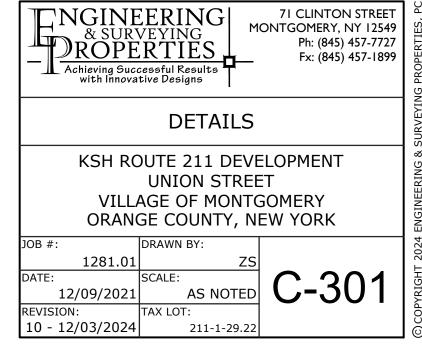- 2. REINFORCEMENT TO BE IN CONFORMANCE WITH ASTM A615 GRADE 60.
- 3. CONTRACTOR TO ORDER MANHOLE SECTIONS FROM MANUFACTURER TO MATCH REQUIRED ELEVATIONS AND INVERTS PER PLAN.
- 4. ANY MANHOLE WITHIN PAVEMENT AREA SHALL BE CAPABLE OF WITHSTANDING HS-20
- 5. PRECAST CONCRETE MANHOLE COMPONENTS BY WOODARDS CONCRETE PRODUCTS OR APPROVED EQUAL .

SUB-BASE SHALL BE A MINIMUM OF 12" IN THICKNESS.

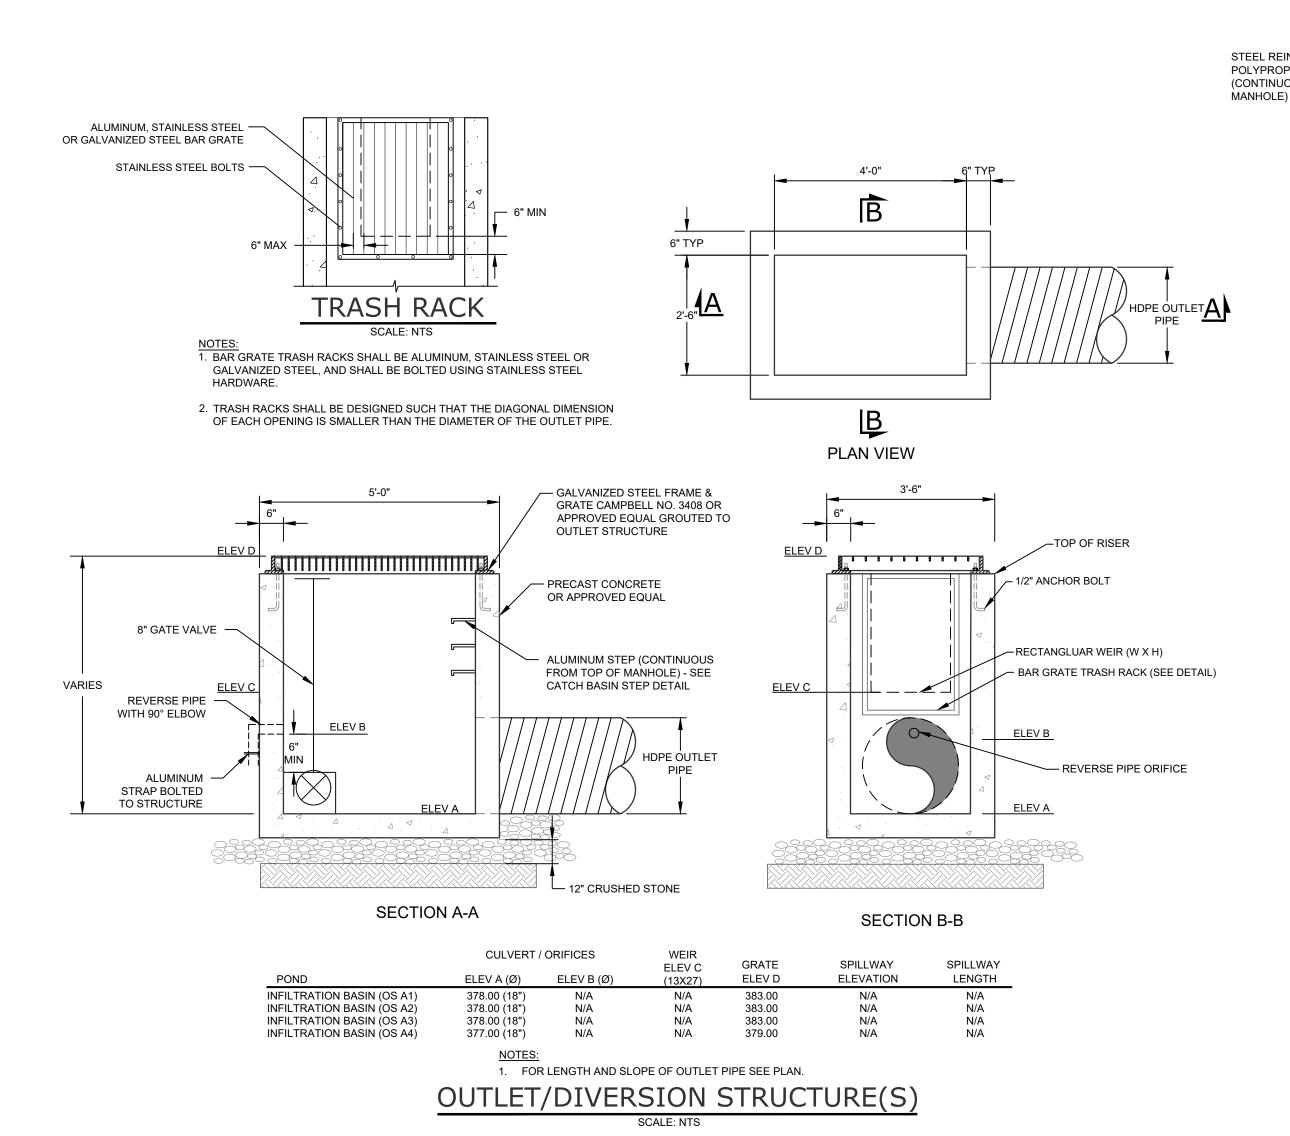6. FOR ANY STRUCTURE LOCATED WITHIN THE TOWN RIGHT-OF-WAY, CRUSHED STONE

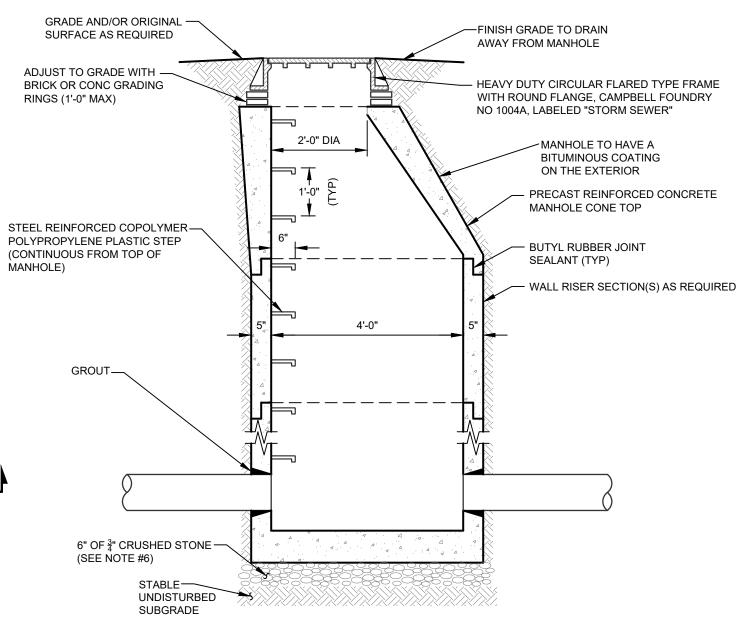

PERMEABILITY: 1 X 10^-6 CM/S (ASTM D 5084) PLASTICITY INDEX OF SOILS: ≥ 15% (ASTM D 4318) LIQUID LIMIT OF SOILS: ≥ 30% ( ASTM D 4318) PASSING OF 200 SIEVE: ≥ 50% (ASTM D 422) MAXIMUM PARTICLE SIZE:

≥ 95% OF MAXIMUM DRY DENSITY (ASTM D 1557) COMPACTION: ± 3.0% OF OPTIMUM MOISTURE CONTENT (ASTM D 1557) ALTERNATIVE IMPERMEABLE LINER 30 MILL (ASTM D 751) MINIMUM THICKNESS: TENSILE STRENGTH: 1,100 LBS (ASTM D 412) ELONGATION: 200% (ASTM D 412) TEAR RESISTANCE: 150 LBS/IN (ASTM D 624) PERMEABILITY: 1 X 10^-3 CM/S (ASTM D 814)


### CLAY FOREBAY POND LINER SCALE: NTS

# DEED TECT LIGHT DECLINE

<u>DE</u>	EP TI	EST	HOLE RESULTS
TEST HOLE #	DATE		DEPTH DESCRIPTION
INF 01	02/16/2022	0" - 6" 6" - 5' 5' - 8'	TOPSOIL TAN SANDY LOAM TAN SILTY LOAM WITH GRAVEL NO WATER, NO MOTTLING, NO ROCK
INF 02	02/16/2022	0" - 6" 6" - 4'	TOPSOIL TAN SILTY CLAY LOAM WITH GRAVEL NO WATER, NO MOTTLING, NO ROCK
INF 03	02/16/2022	0" - 6" 6" - 3' 3' - 6' 6' - 12'	TOPSOIL TAN SILTY LOAM TAN SILTY LOAM WITH GRAVEL GRAVEL NO WATER, NO MOTTLING, NO ROCK
INF 04	02/16/2022	0" - 6" 6" - 3' 3' - 6' 6' - 12'	TOPSOIL TAN SILTY LOAM TAN SILTY LOAM WITH GRAVEL GRAVEL NO WATER, NO MOTTLING, NO ROCK
INF 05	02/16/2022	0" - 6" 6" - 6'	TOPSOIL TAN SILTY CLAY LOAM WATER AT 4' , NO MOTTLING, NO ROCK
INF 06	02/16/2022	0" - 6" 6" - 4' 4' - 11'	TOPSOIL TAN SILTY CLAY LOAM TAN SILT LOAM WITH GRAVEL WATER AT 11', NO MOTTLING, NO ROCK
INF 07	02/16/2022	0" - 4" 4" - 3' 3' - 8' 8' - 18	TOPSOIL TAN SILTY CLAY LOAM BROWN SILT LOAM BROWN SANDY LOAM WITH GRAVEL NO WATER, NO MOTTLING, NO ROCK
INF 08	02/16/2022	0" - 6" 6" - 3' 3' - 8' 8' - 18'	TOPSOIL TAN SILT CLAY LOAM BROWN LOAM BROWN SANDY LOAM WITH GRAVEL NO WATER, NO MOTTLING, NO ROCK

# INFILTRATION TEST RESULTS

TEST HOLE#	TEST HOLE DEPTH	HOLE DIA	TIME	(WATE		N TEST RUNS HES OVER ONE	HOUR)	AVERAG DROP						
			START	8:47 AM	9:38 AM	10:46 AM	11:54 AM							
02/16/22 IT-01	6'	8"	FINISH	9:38 AM	10:36 AM	11:40 AM	12:19 PM	> 24'						
11-01			DROP	>24	>24	>24	>24	-						
			START	9:11 AM	10:11 AM	11:11 AM	12:11 PM							
02/16/22 IT-02	2'	8"	FINISH	10:11 AM	11:11 AM	12:11 PM	1:11 PM	15.50						
11-02			DROP	15	15	16.5	15.75	-						
			START	9:40 AM	10:40 AM	11:40 AM	12:40 AM							
02/16/22 IT-03	10'	8"	FINISH	10:40 AM	11:40 AM	12:40 PM	1:40 PM	> 24'						
11-03			DROP	>24	>24	>24	>24							
			START	10:15 AM	10:45 AM	11:42 AM	12:08 PM							
02/16/22 IT-04	10'	8"	FINISH	10:45 AM	11:42 AM	12:08 PM	12:14 PM	> 24'						
11-04			DROP	>24	>24	>24	>24	-						
	2 2'		START	12:10 PM	1:10 PM	2:10 PM	3:10 PM							
02/16/22 IT-05		2'	2'	2'	2'	2'	' ' ' '	8"	FINISH	1:10 PM	2:10 PM	3:10 PM	4:10 PM	10.50
11-05									DROP	12.5	10.5	10	9.5	
			START	12:05 PM	1:05 PM	1:50 PM	2:15 PM							
02/16/22 IT-06	2 8'	8'	2 8'		1:05 PM	1:50 PM	2:15 PM	2:23 PM	> 24"					
11-00			DROP	>24	>24	>24	>24							
	16'		START	1:56 PM	2:11 PM	2:48 PM	3:20 PM							
02/16/22 IT-07		16' 8"	FINISH	2:11 PM	2:48 PM	3:20 PM	3:38 PM	> 24						
						DROP	>24	>24	>24	>24				
			START	2:39 PM	2:51 PM	3:22 PM	3:36 PM							
02/16/22 IT-08	16'	8"	FINISH	2:51 PM	3:32 PM	3:36 PM	3:41 PM	> 24						
11-00			DROP	>24	>24	>24	>24	1						

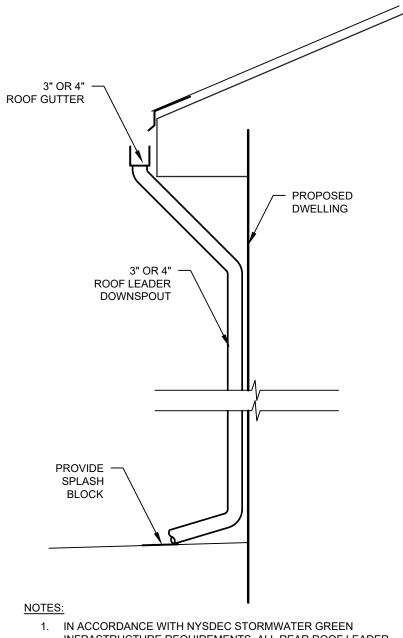

INFRASTRUCTURE REQUIREMENTS, ALL REAR ROOF LEADER DOWNSPOUTS SHALL DISCHARGE EFFLUENT ALONG THE SURFACE FOR INFILTRATION.

2. CONNECTION OF ROOF LEADERS TO CLOSED SYSTEMS IS PROHIBITED.

3. HOMEOWNERS ASSOCIATION SHALL MAINTAIN SPLASH BLOCK LAWN AREA AS SHOWN ON THE PLANS TO PROVIDE INFILTRATION OF STORMWATER ROOF RUNOFF.




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JOB #:	DRAWN BY:			
1281.01	ZS			
DATE: 12/09/2021	SCALE: AS NOTED	C-302		
REVISION:	TAX LOT:			
10 - 12/03/2024	211-1-29.22			



MATCH PAVEMENT —

GRADE AND/OR

FINISH GRADE TO DRAIN

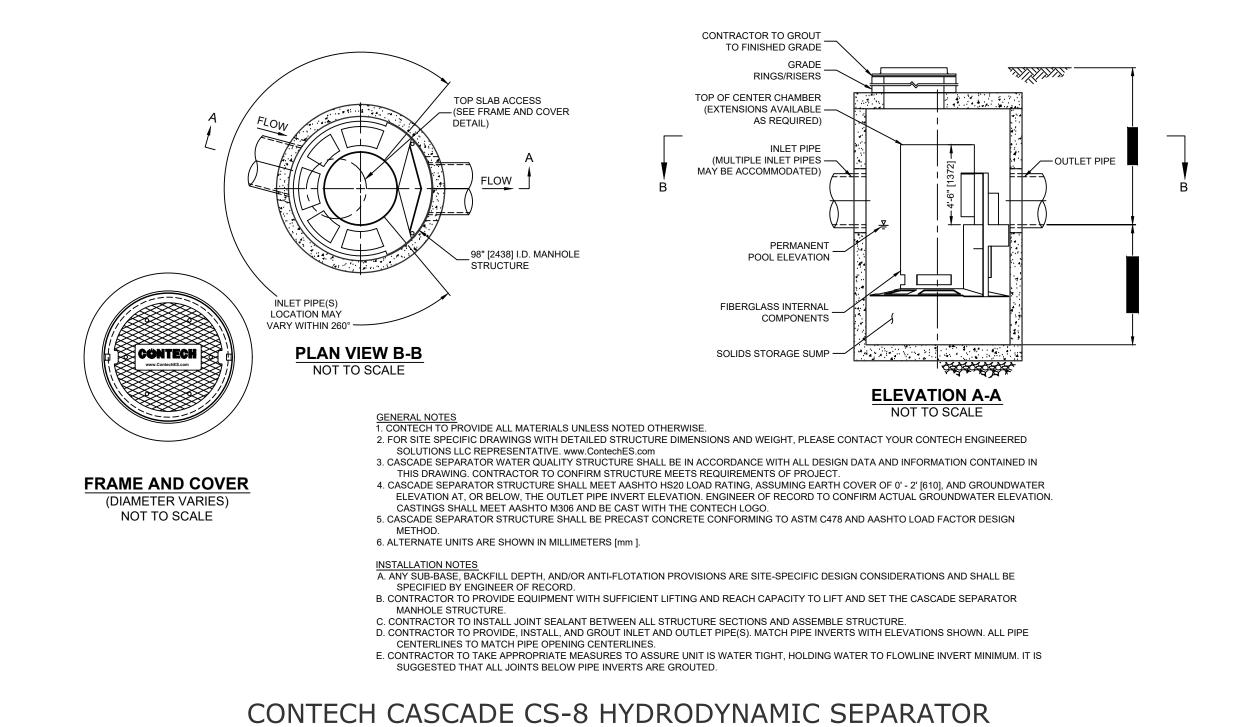AWAY FROM MANHOLE

HEAVY DUTY MANHOLE

CAMPBELL #1009A WITH

"SANITARY SEWER" CAST

- PRECAST REINFORCED

CONE TOP BY WOODARDS

AROUND PERIMETER OF

- BITUMINOUS WATERPROOFING

- PROPOSED 8" PVC SEWER MAIN

- PRECAST MANHOLE BASE BY

WOODARDS CONCRETE

CONCRETE MANHOLE

PORE-CAST UNIT

- PROPOSED

CONCRETE

CHANNEL

1. CONCRETE TO HAVE A MINIMUM COMPRESSIVE STRENGTH OF 4000 PSI @ 28 DAYS.

2. REINFORCEMENT TO BE IN CONFORMANCE WITH ASTM A615 GRADE 60.

3. ALL MANHOLE SECTIONS TO CONFORM WITH ASTM SPECIFICATION C-478

4. ALL MANHOLES WITHIN PAVEMENT AREAS SHALL BE DESIGNED TO WITHSTAND

ORIGINAL SURFACE

OR AS REQUIRED

STEEL REINFORCED -

ADJUST TO GRADE WITH -

COURSES OF BRICK OR

COPOLYMER POLYPROPYLENE

PLASTIC STEP (CONTINUOUS

FROM TOP OF MANHOLE)

NYSDOT ITEM #4 COMPACTED -IN MAX. 9" LIFTS TO 95% MODIFIED

BUTYL RUBBER JOINT -

FLEXIBLE CONNECTOR

12" OF 3" CRUSHED STONE

UNDISTURBED SOIL

FOUNDATION


NOTES:

HS-25 LOADING.

PROCTOR DENSITY

SEALANT (TYP.)

LOCKJOINT

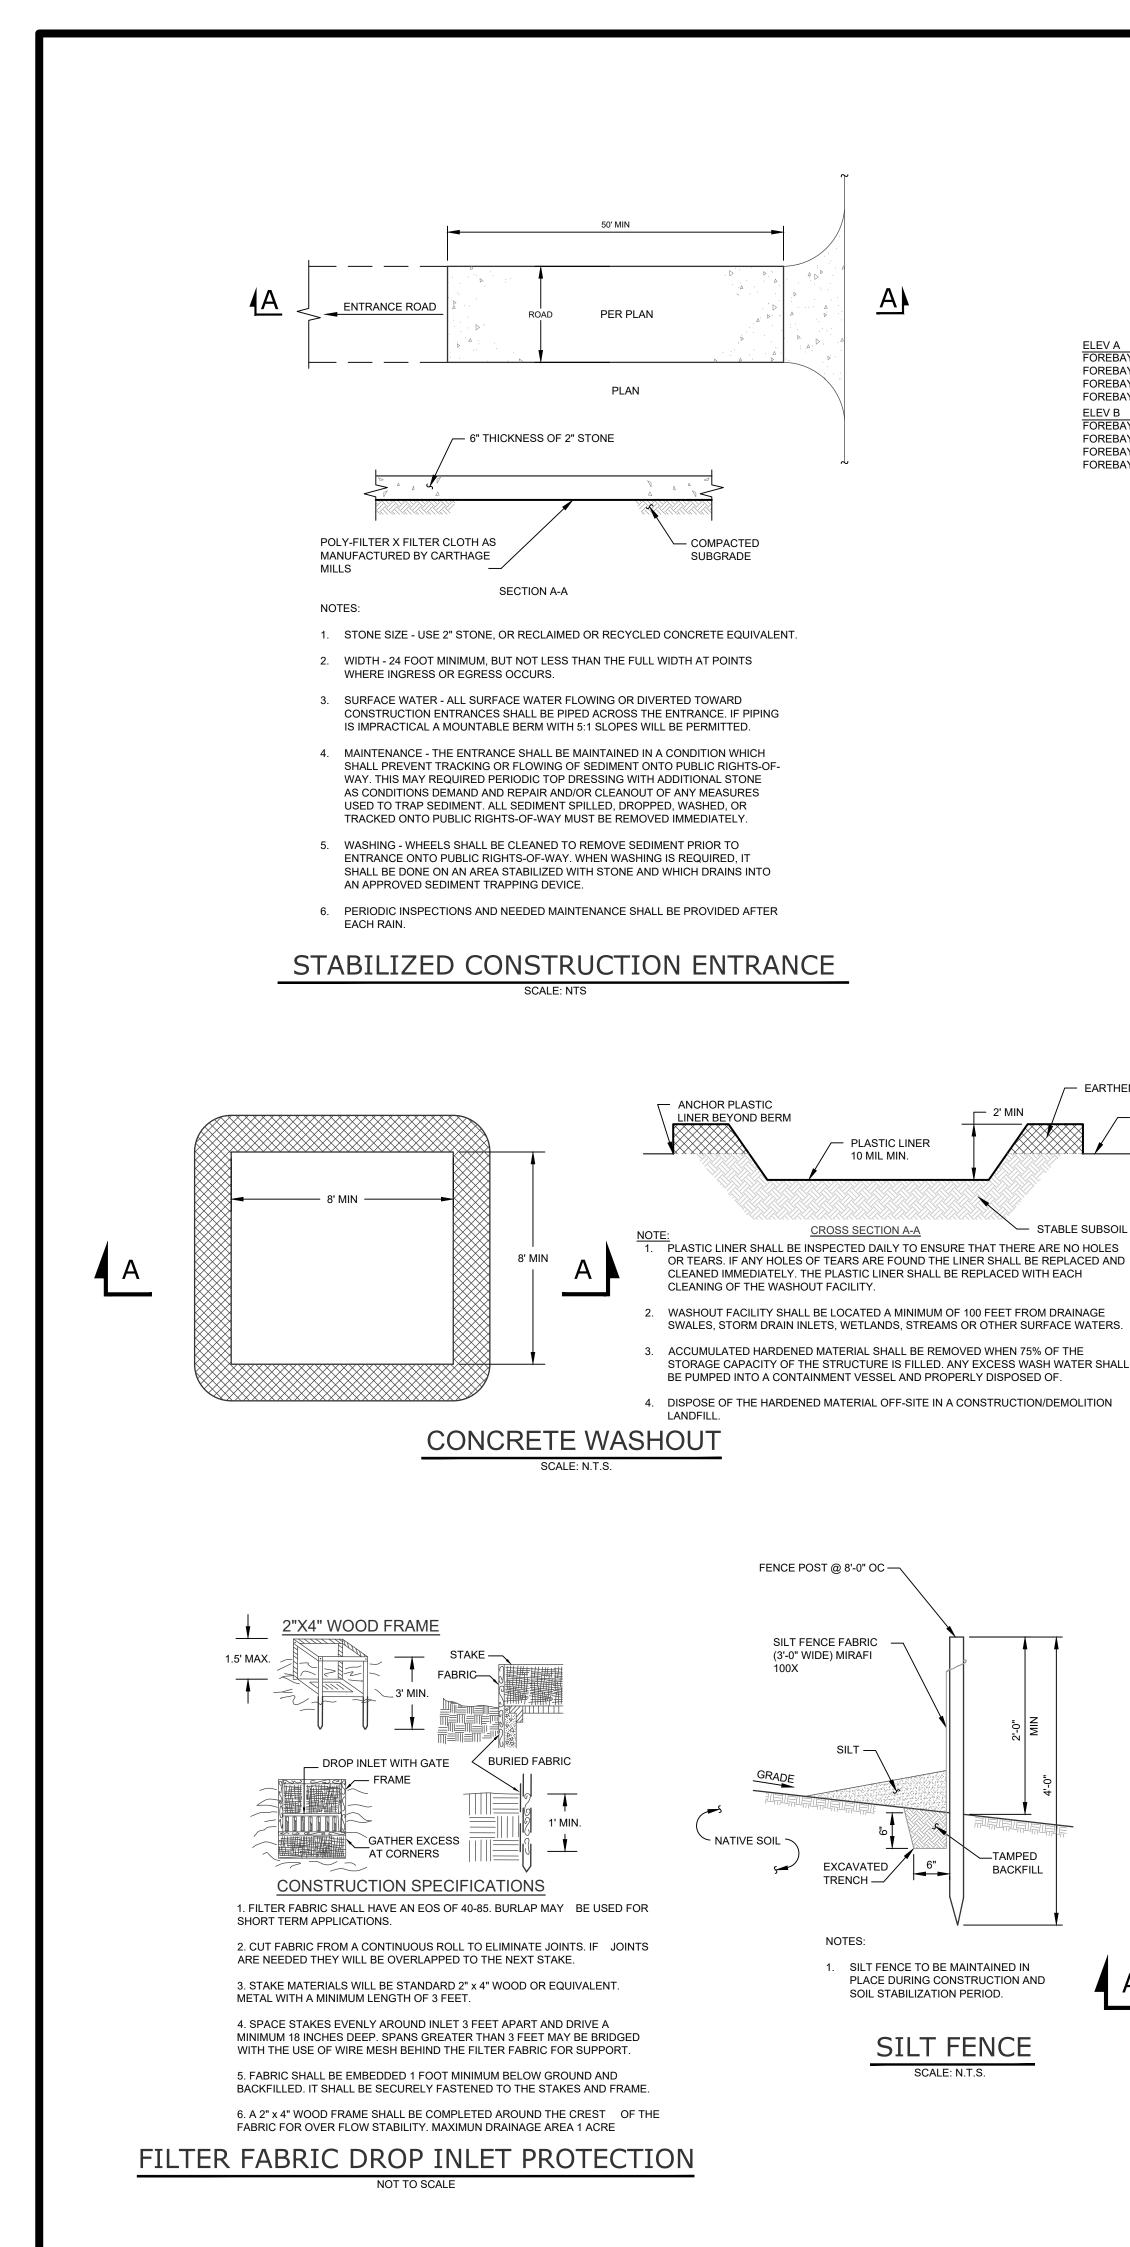

**OUTLET PROTECTION SIZING CALCULATIONS** 

FES A2

FES A4

FES 4

FES 11

FES 18

FES 47

24 | 29.6 | 9.4 | 7 | 11 | 18 | 20

15 8.4 6.8 5 8 10 11.25


24 87.2 27.8 18 27 32 34

24 | 29.6 | 9.4 | 8 | 11 | 18 | 20 |

24 | 29.7 | 9.5 | 8 | 11 | 18 | 20 |


18 34.9 19.7 14 20 23 24.5

18 21.3 12.1 9 13 20 21.5 18 18

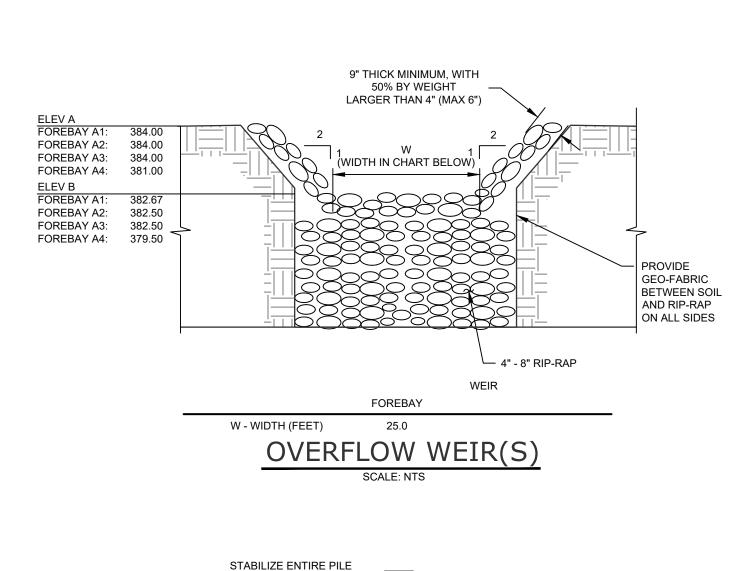

EARTHEN BERM

— EXISTING GRADE

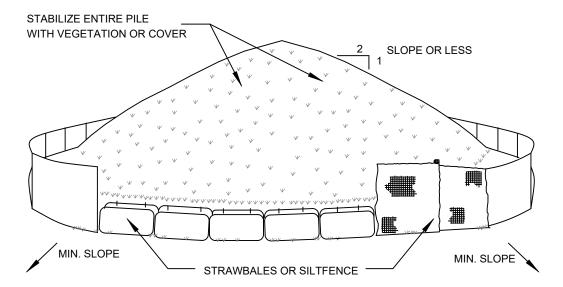

1. AREA CHOSEN FOR STOCKPILING OPERATIONS SHALL BE DRY AND STABLE. 2. MAXIMUM SLOPE OF STOCKPILE SHALL BE 1:2. 3. UPON COMPLETION OF SOIL STOCKPILING, EACH PILE SHALL BE SURROUNDED A WITH EITHER SILT FENCING OR STRAWBALES, THEN STABILIZED WITH VEGETATION OR COVERED.

ROCK RIPRAP ~

SECTION A-A

SECTION B-B

FES OUTLET PROTECTION

— FLARED END SECTION

NON-WOVEN GEOTEXTILE FX-100HS

AS MANUFACTURED BY CARTHAGE

NON-WOVEN GEOTEXTILE

FX-100HS AS MANUFACTURED BY

CARTHAGE MILLS

ROCK RIP-RAP SHALL BE WELL

GRADED, WITH 50% BY WEIGHT


LARGER THAN D AS NOTED

IN SIZING CALCULATION

—TOP OF RIPRAP

(ROLLED EROSION CONTROL PRODUCT)

GUIDE.

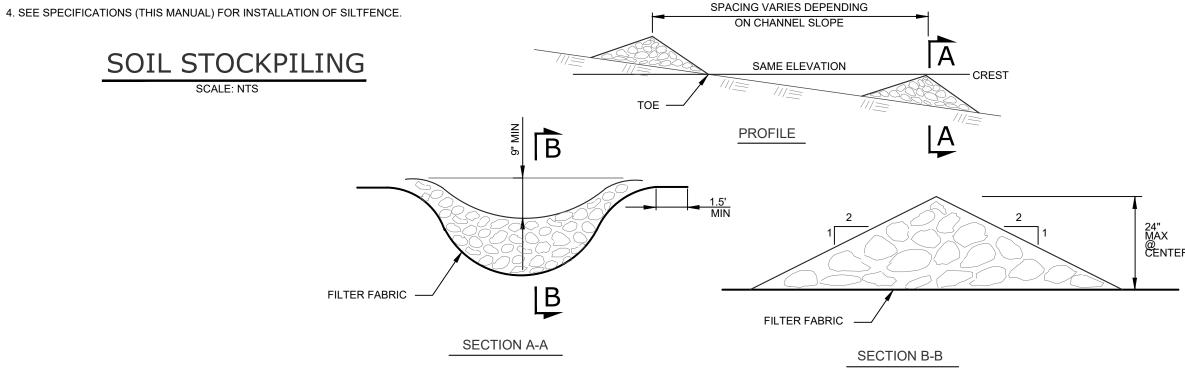

PRIOR TO INSTALLATION OF ANY RECP'S.

TOP OF SLOPE

/<del>\_\_\_\_</del>/

1. ROLLED EROSION CONTROL PRODUCT (RECP'S) SHALL BE USED ON ALL CONSTRUCTED SLOPES GREATER THAN 3 HORIZONTAL

2. PREPARATION OF THE SOIL INCLUDING ANY NECESSARY APPLICATION OF LIME, FERTILIZER, AND SEED SHALL BE COMPLETED

ANCHORING THE RECP'S IN A 6" DEEP BY 6" WIDE TRENCH WITH APPROXIMATELY 12" OF RECP'S EXTENDED BEYOND THE

UP-SLOPE PORTION OF THE TRENCH. ANCHOR THE RECP'S WITH A ROW OF STAPLES/STAKES APPROXIAMTELY 12" APART IN

THE BOTTON OF THE TRENCH. BACKFILL AND COMPACT THE TRENCH AFTER STAPLING. APPLY SEED TO COMPACTED SOIL AND FOLD REMAINING 12" PORTION OF RECP'S BACK OVER SEED AND COMPACTED SOIL. SECURE RECP'S OVER COMPACTED

3. INSTALL RECP - NORTH AMERICAN GREEN BIONET S150BN OR APPROVED EQUAL. BEGIN AT THE TOP OF THE SLOPE BY

SOIL WITH A ROW OF STAPLES/STAKES SPACE APPROXIMATELY 12" APART ACROSS THE WIDTH OF THE RECP'S.

4. ROLL THE RECP'S DOWN THE SLOPE OR HORZONTALLY ACROSS THE SLOPE. ALL RECP'S MUST BE SECURLY FASTENED TO SOIL SURFACE BY PLACING STAPLES/STAKES IN APPROPRIATE LOCATIONS AS SHOWN IN THE PRODUCT'S STAPLE PATTERN

5. THE EDGES OF PARALLEL RECP'S MUST BE STAPLED WITH APPROXIMATELY 2" TO 5" OVERLAP DEPENDING ON RECP'S TYPE.

3" OVERLAP. STAPLE THROUGH OVERLAPPED AREA, APPROXIMATELY 12" APART ACROSS THE ENTIRE RECP'S WIDTH.

6. CONSECUTIVE RECP'S SPLICED DOWN THE SLOPE MUST BE PLACED END OVER END (SHINGLE STYLE) WITH AN APPROXIAMATE

SLOPE STABILIZATION


## CONSTRUCTION SPECIFICATIONS:

CUTTING AROUND THE DAM.

- 1. STONE SHALL BE MAXIMUM SIZE OF 12" WITH 50 TO 100 PERCENT BY WEIGHT LARGER THAN 6" AND 0 TO 10 PERCENT SMALLER THAN 1/2".
- 2. FILTER FABRIC SHALL BE POLY-FILTER X CLOTH AS MANUFACTURED BY CARTHAGE MILLS
- 3. STONE WILL BE PLACED ON A FILTER FABRIC FOUNDATION AT LOCATIONS SHOWN ON THE PLAN.
- 4. SET SPACING OF CHECK DAMS TO ASSURE THAT THE ELEVATIONS OF THE CREST OF THE DOWNSTREAM DAM IS AT THE SAME ELEVATION AS THE TOE OF THE UPSTREAM DAM.
- 5. EXTEND THE STONE A MINIMUM OF 1.5 FEET BEYOND THE DITCH BANKS TO PREVENT

ARE NOT SUBJECT TO DAMAGE OR BLOCKAGE FROM DISPLACED STONES.

- 6. PROTECT THE CHANNEL DOWNSTREAM OF THE LOWEST CHECK DAM FROM SCOUR AND EROSION WITH STONE OR LINER AS APPROPRIATE.
- 7. ENSURE THAT CHANNEL APPURTENANCES SUCH AS CULVERT ENTRANCES BELOW CHECK DAMS

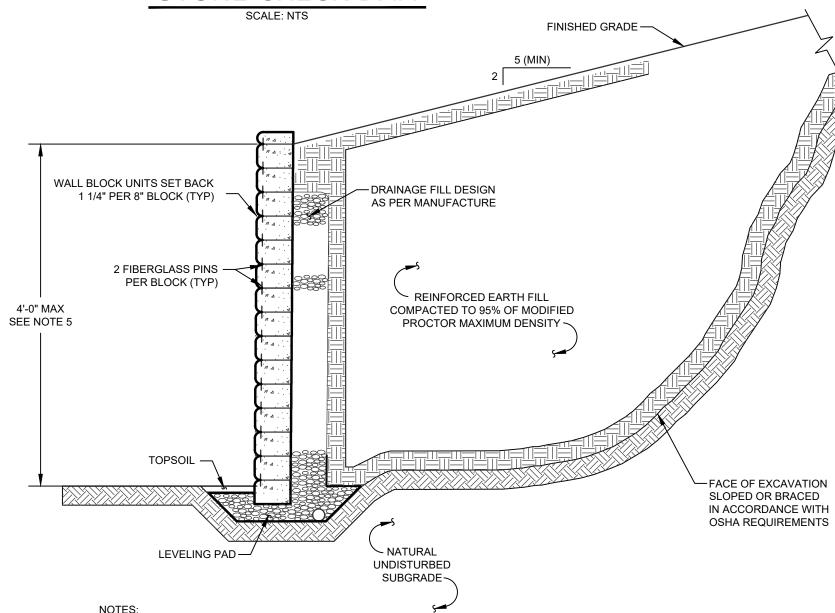

# 1. PROPOSED KEYSTONE KS HALF CENTURY RETAINING WALL SHALL BE DESIGNED AS PER THE MANUFACTURER.

- 2. FENCING SHALL BE INSTALLED FOR AS SHOWN ON THE PLANS, IN ACCORDANCE WITH MANUFACTURER'S
- RECOMMENDATIONS. 3. COLORS TO MATCH FOUNDATION STONE.
- 4. FOR WALLS OVER HEIGHTS OF 4'-0" SEE SPECIFIC ENGINEERED WALL DETAILS AS PREPARED BY OTHERS
- 5. PRIOR TO CONSTRUCTION, DESIGN OF RETAINING WALLS SHALL BE PREPARED BY A LICENESED NEW YORK STATE PROFESSIONAL ENGINEERAND BE SUBMITTED TO THE VILLAGE OF MONTGOMERY BUILDING INSPECTOR / ENGINEER

TYPICAL MSE RETAINING WALL

### **EROSION AND SEDIMENTATION CONTROL NOTES**

- SITE DISTURBANCE SHALL BE LIMITED TO THE MINIMUM NECESSARY GRADING AND VEGETATION REMOVAL REQUIRED FOR CONSTRUCTION.
- ORANGE CONSTRUCTION FENCE LOCATIONS SHALL BE STAKED BY A SURVEYOR AND INSTALLATION SHALL BE CONFIRMED BY THE ENGINEER PRIOR TO ANY LAND DISTURBANCE WITHIN 125 FEET OF AN EXISTING WETLAND AND IN AREAS WHERE TREES AND STONE WALLS ARE TO BE PRESERVED. ALL ORANGE CONSTRUCTION FENCING SHALL BE MAINTAINED THROUGHOUT CONSTRUCTION TO PROTECT SENSITIVE AREAS. THE ORANGE CONSTRUCTION FENCING WILL BE REMOVED UPON FINAL STABILIZATION OF ALL AREAS WITHIN 125 FEET OF FENCING.
- 3. TEMPORARY EROSION CONTROL MEASURES, INCLUDING SILT FENCES AND/OR STRAW BALE DIKES, DRAINAGE STRUCTURES, AND RIP-RAP PROTECTION SHALL BE INSTALLED PRIOR TO GROUND DISTURBANCE FOR GRADING AND CONSTRUCTION.
- 4. ALL DISTURBED AREAS SHALL BE SEEDED AND MULCHED AS SOON AS PRACTICAL FOLLOWING DISTURBANCE TO STABILIZE BARE SOIL AND PROMOTE THE PROMPT RE-ESTABLISHMENT OF
- 4.1. AN ADEQUATE SEEDBED SHALL BE PREPARED BY SCARIFYING COMPACTED SOIL AND REMOVING SURFACE DEBRIS AND OBSTACLES. 4.2. LIME SHALL BE APPLIED SUFFICIENTLY TO ATTAIN A SOIL ACIDITY PH OF 6.0 TO 7.0.
- 4.3. FERTILIZER (5-10-10 MIXTURE OR EQUIVALENT) SHALL BE APPLIED PER SOIL TEST RESULTS OR AT A RATE OF 600 LBS PER ACRE 4.4. DISTURBED AREAS WHICH WILL REMAIN TEMPORARILY FALLOW FOR PERIODS GREATER THAN 30 DAYS SHALL BE SEEDED AT THE FOLLOWING RATE TO PRODUCE TEMPORARY GROUND COVER: 30 LBS. RYEGRASS (ANNUAL OR PERENNIAL) PER ACRE. DURING THE WINTER, USE 100 LBS.
- CERTIFIED "AROOSTOOK" WINTER RYE (CEREAL RYE) PER ACRE. 4.5. PERMANENT SEEDING SHALL BE APPLIED ON 4" MIN TOPSOIL AT THE FOLLOWING RATE:
- 8 LBS EMPIRE BIRDSFOOT TREFOIL OR COMMON WHITE CLOVER PER ACRE PLUS 20 LBS TALL FESCUE PER ACRE PLUS 2 LBS REDTOP OR 5 LBS RYEGRASS (PERENNIAL) PER ACRE
- 4.6. ALL SEEDING SHALL BE PERFORMED USING THE BROADCAST METHOD OR HYDROSEEDING, UNLESS OTHERWISE APPROVED 4.7. ALL DISTURBED AREAS SHALL BE STABILIZED SUBSEQUENT TO SEEDING BY APPLYING 2 TONS OF STRAW MULCH PER ACRE. STRAW MULCH SHALL BE ANCHORED BY APPLYING 750 LBS OF WOOD FIBER MULCH PER ACRE WITH A HYDROSEFDER OR TUCKING THE MULCH WITH SMOOTH DISCS OR OTHER MULCH ANCHORING TOOLS TO A DEPTH OF 3". MULCH ANCHORING TOOLS SHALL BE PULLED ACROSS SLOPES ALONG TOPOGRAPHIC CONTOURS.
- 5. ALL EROSION AND SEDIMENTATION CONTROL MEASURES AND DRAINAGE STRUCTURES SHALL BE INSPECTED FOLLOWING EVERY RAIN EVENT, AND MAINTENANCE AND REPAIRS SHALL BE PERFORMED PROMPTLY TO MAINTAIN PROPER FUNCTION. TRAPPED SEDIMENT SHALL BE REMOVED AND DEPOSITED IN A PROTECTED AREA IN A PROPER MANNER WHICH WILL NOT RESULT IN EROSION.
- 6. TEMPORARY CONTROL MEASURES SHALL REMAIN IN PLACE UNTIL DISTURBED AREAS ARE PERMANENTLY STABILIZED AND GROUND COVER IS COMPLETELY REESTABLISHED. FOLLOWING STABILIZATION, TEMPORARY MEASURES SHALL BE REMOVED TO AVOID INTERFERENCE WITH
- 7. ALL STORM INLETS TO BE PROTECTED FROM SEDIMENTATION DURING CONSTRUCTION.
- 8. SYNTHETIC OR ORGANIC SOIL STABILIZERS MAY BE USED UNDER SUITABLE CONDITIONS AND IN SUFFICIENT QUANTITIES.
- 9. MULCH NETTING SUCH AS PAPER, JUTE, EXCELSIOR, COTTON OR PLASTIC MAY BE USED. STAPLE IN PLACE. OVER HAY OR STRAW MULCH. USE A DEGRADABLE NETTING IN AREAS TO BE MOWED.
- 10. STABILIZATION OF STEEP SLOPES SHALL BE ACHIEVED BY APPLYING LIME AND FERTILIZER AS SPECIFIED ABOVE AND SEEDING WITH THE FOLLOWING MIXTURE:
- PERENNIAL RYE GRASS CROWN VETCH SPREADING FESCUE

11. OPTIMUM SEEDING PERIODS ARE 3/15-6/1 AND 8/1-10/15

## **EARTHWORK CONSTRUCTION NOTES**

- 1. ALL WORK TO BE PERFORMED TO THE SPECIFICATIONS OF THE VILLAGE OF MONTGOMERY
- 2. ALL TOPSOIL, ROOTS, STUMPS AND OTHER DELETERIOUS MATERIAL SHALL BE REMOVED FROM ALL
- 3. ALL FILL FOR POND CONSTRUCTION, BELOW BUILDINGS AND PAVEMENT TO BE COMPACTED TO 95% OF MAXIMUM DRY DENSITY AS DETERMINED BY MODIFIED PROCTOR COMPACTION TEST ASTM D1557. 4. CELLAR, ROOF AND FOOTING DRAINS SHALL CONNECT TO THE STORM DRAINAGE SYSTEM OR OTHER FREE-FLOWING OUTLET AT A MINIMUM SLOPE OF 0.5%. FOOTING DRAIN SHALL BE INSTALLED BENEATH
- 5. COMPLETION OF GRADING AND BASIN, BERMS AFTER OCTOBER 15 SHALL REQUIRE MULCHING AND ANCHORING IN ACCORDANCE WITH NOTES ENTITLED "SEDIMENTATION EROSION CONTROL". 6. ALL SLOPES IN EXCESS OF 3H:1V SHALL BE CONSTRUCTED WITH LOCALLY AVAILABLE GLACIAL TILL. THE EMBANKMENT FILL SHALL BE PLACED IN SIX-INCHTHICK LIFTS. EACH LIFT SHALL BE PLACED AND
- COMPACTED TO 95% OF MAXIMUM DRY DENSITY AS DETERMINED BY MODIFIED PROCTOR COMPACTION 7. CONSTRUCT POND EMBANKMENT WITH LOCALLY AVAILABLE GLACIAL TILL WITH 3H:1V SIDE SLOPES OR AS NOTED ON PLAN. THE EMBANKMENT FILL SHALL BE PLACED IN A SIX-INCH THICK CONTINUOUS LAYER
- OVER THE ENTIRE LENGTH.EACH LIFT SHALL BE PLACED AT OPTIMUM MOISTURE CONTENT AND COMPACTED TO 95% OF MAXIMUM DRY DENSITY AS DETERMINED BY MODIFIED PROCTOR COMPACTION
- 8. STABILIZATION OF POND BERMS, AND ALL SLOPES IN EXCESS OF 3H:1V IN ACCORDANCE WITH "EROSION AND SEDIMENTATION CONTROL NOTES". 9. ALL POND OUTLETS SHALL HAVE SEEPAGE CONTROL COLLARS PLACED AT 1/3 AND 2/3 THE WIDTH OF
- 10. SOIL RESTORATION SHALL BE APPLIED TO ALL DISTURBED AREAS THAT WILL REMAIN AS PERVIOUS
- SURFACES. SOIL RESTORATION SHALL CONSIST OF THE FOLLOWING: 10.A. APPLY 3 INCHES OF COMPOST OVER SUBSOIL
- 10.B. TILL COMPOST INTO SUBSOIL TO A DEPTH OF AT LEAST 12 INCHES USING A CAT-MOUNTED RIPPER, TRACTOR MOUNTED DISC, OR TILLER, MIXING, AND CIRCULATING AIR AND COMPOST INTO
- 10.C. ROCK-PICK UNTIL UPLIFTED STONE/ROCK MATERIALS OF FOUR INCHES AND LARGER SIZE ARE
- 10.D. APPLY TOPSOIL TO A DEPTH OF 6 INCHES.
- 10.E. VEGETATE IN ACCORDANCE WITH LANDSCAPE PLAN.

### SEQUENCE OF **CONSTRUCTION ACTIVTY**


THAN 21 DAYS FROM LAST DISTURBANCE.

- 1. PRE-CONSTRUCTION MEETING: ONE WEEK BEFORE CONSTRUCTION, SITE DISTURBANCE, OR EQUIPMENT STAGING ACTIVITIES AN EVALUATION OF THE SITE WILL BE PERFORMED WITH VILLAGE PERSONNEL, VILLAGE ENGINEER, SITE DESIGN ENGINEER, CONTRACTOR TO DISCUSS GENERAL CONSTRUCTION PROCEDURES AND SEQUENCING. DURING THIS MEETING SENSITIVE AREAS OF THE PROPERTY SHALL BE DELINEATED AND MARKED OUT WITH ORANGE CONSTRUCTION FENCE (I.E. TREES,
- 2. CONSTRUCTION STAGING: STAKE OUT LIMIT OF DISTURBANCE. INSTALL SILT FENCE DOWN HILL OF PROPOSED CONSTRUCTION. INSTALL STABILIZED CONSTRUCTION ENTRANCE AND STABLIZE CONSTRUCTION ROAD(S). INSTALL TEMPORARY SEDIMENT TRAP. INSTALL PERMANENT/TEMPORARY GRASSED
- 3. CLEARING AND GRUBBING: REMOVE VEGETATION FROM AREA OF CONSTRUCTION. STRIP TOPSOIL AND STOCKPILE IN AREAS SHOWN ON THE PLAN. INSTALL SEDIMENT BARRIERS AROUND AND ESTABLISH TEMPORARY VEGETATION ON TOPSOIL STOCKPILES. 4. ROUGH GRADING: CUT AND FILL SITE TO APPROXIMATE ELEVATIONS SHOWN ON PERMANENT STABLIZATION IN AREAS THAT ARE COMPLETE. ESTABLISH TEMPORARY STABLIZATION ON AREAS THAT WILL BE GRADED AGAIN MORE
- 5. ROAD/BUILDING CONSTRUCTION AND UTILITY INSTALLATION: FINAL GRADING AND CONSTRUCTION OF ROADWAYS. BUILDING EXCAVATION AND CONSTRUCTION. INSTALL UTILITIES. INSTALL DRAINAGE INLET AND OUTLET PROTECTION AS EACH INLET/OUTLET IS CONSTRUCTED. ENSURE ALL EROSION
- CONTROL MEASURES ARE IN WORKING ORDER. 6. FINAL GRADING AND LANDSCAPING: REMOVE TEMPORARY SEDIMENT TRAPS AND INSTALL PERMANENT WATER QUALITY/QUANTITY FACILITIES. COMPLETE FINE GRADING OF SITE. SPREAD TOPSOIL AND PREPARE FOR PERMANENT SEEDING AND PLANTING. ESTABLISH PERMANENT VEGETATION IN ALL REMAINING UNSTABILIZED AREAS. INSTALL ALL SITE LANDSCAPING AND PLANTINGS.
- 7. POST CONSTRUCTION: UPON STABILIZATION OF THE SITE AND ESTABLISHMENT OF ALL VEGETATION COVER, REMOVE ALL REMAINING TEMPORARY EROSION CONTROL MEASURES SUCH AS SILT FENCE. REMOVE ALL SILT AND DEBRIS FROM THE SITE INCLUDING ROADWAYS, CATCH BASINS AND STORM DRAINS.




No.	DATE	DESCRIPTION
1	01/14/22	REVISED PER PB COMMENTS 12/15/2021
2	05/13/22	REVISED LAYOUT PER TRAFFIC STUDY
3	06/10/22	REVISED PER PB COMMENTS
4	09/16/22	REVISED PER PB COMMENTS
5	12/02/22	REVISED PER PB COMMENTS 09/23/2022
6	03/10/23	REVISED PER PB & PUBLIC COMMENTS
7	04/14/23	REVISED PER PB & PUBLIC COMMENTS
8	05/12/23	REVISED PER PB & PUBLIC COMMENTS
9	06/16/23	REVISED PER PB & PUBLIC COMMENTS
10	12/03/24	REVISED FOR PLANNING BOARD SUBMISSION


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THIS SHEET IS PART OF THE PLAN SET ISSUED FOR	S	HEE JMBI	Т
☐ CONCEPT APPROVAL	N/A	OF	N/A
☑ PLANNING BOARD APPROVAL	15	OF	16
OCDOH REALTY SUBDIVISION APPROVAL	N/A	OF	N/
OCDOH WATERMAIN EXTENSION APPROVAL	N/A	OF	N/A
NYSDEC APPROVAL	N/A	OF	N/A
NYSDOT APPROVAL	N/A	OF	N/A
OTHER	N/A	OF	N/A
☐ FOR BID	N/A	OF	N/A
☐ FOR CONSTRUCTION	N/A	OF	N/A
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JOB #:	DRAWN BY:			

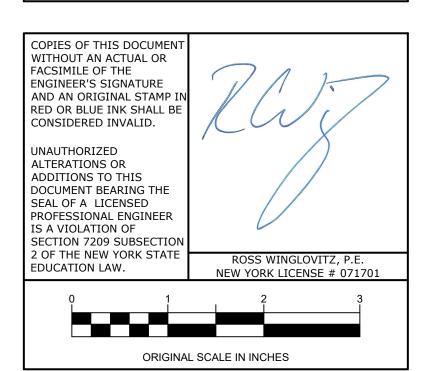10 - 12/03/2024




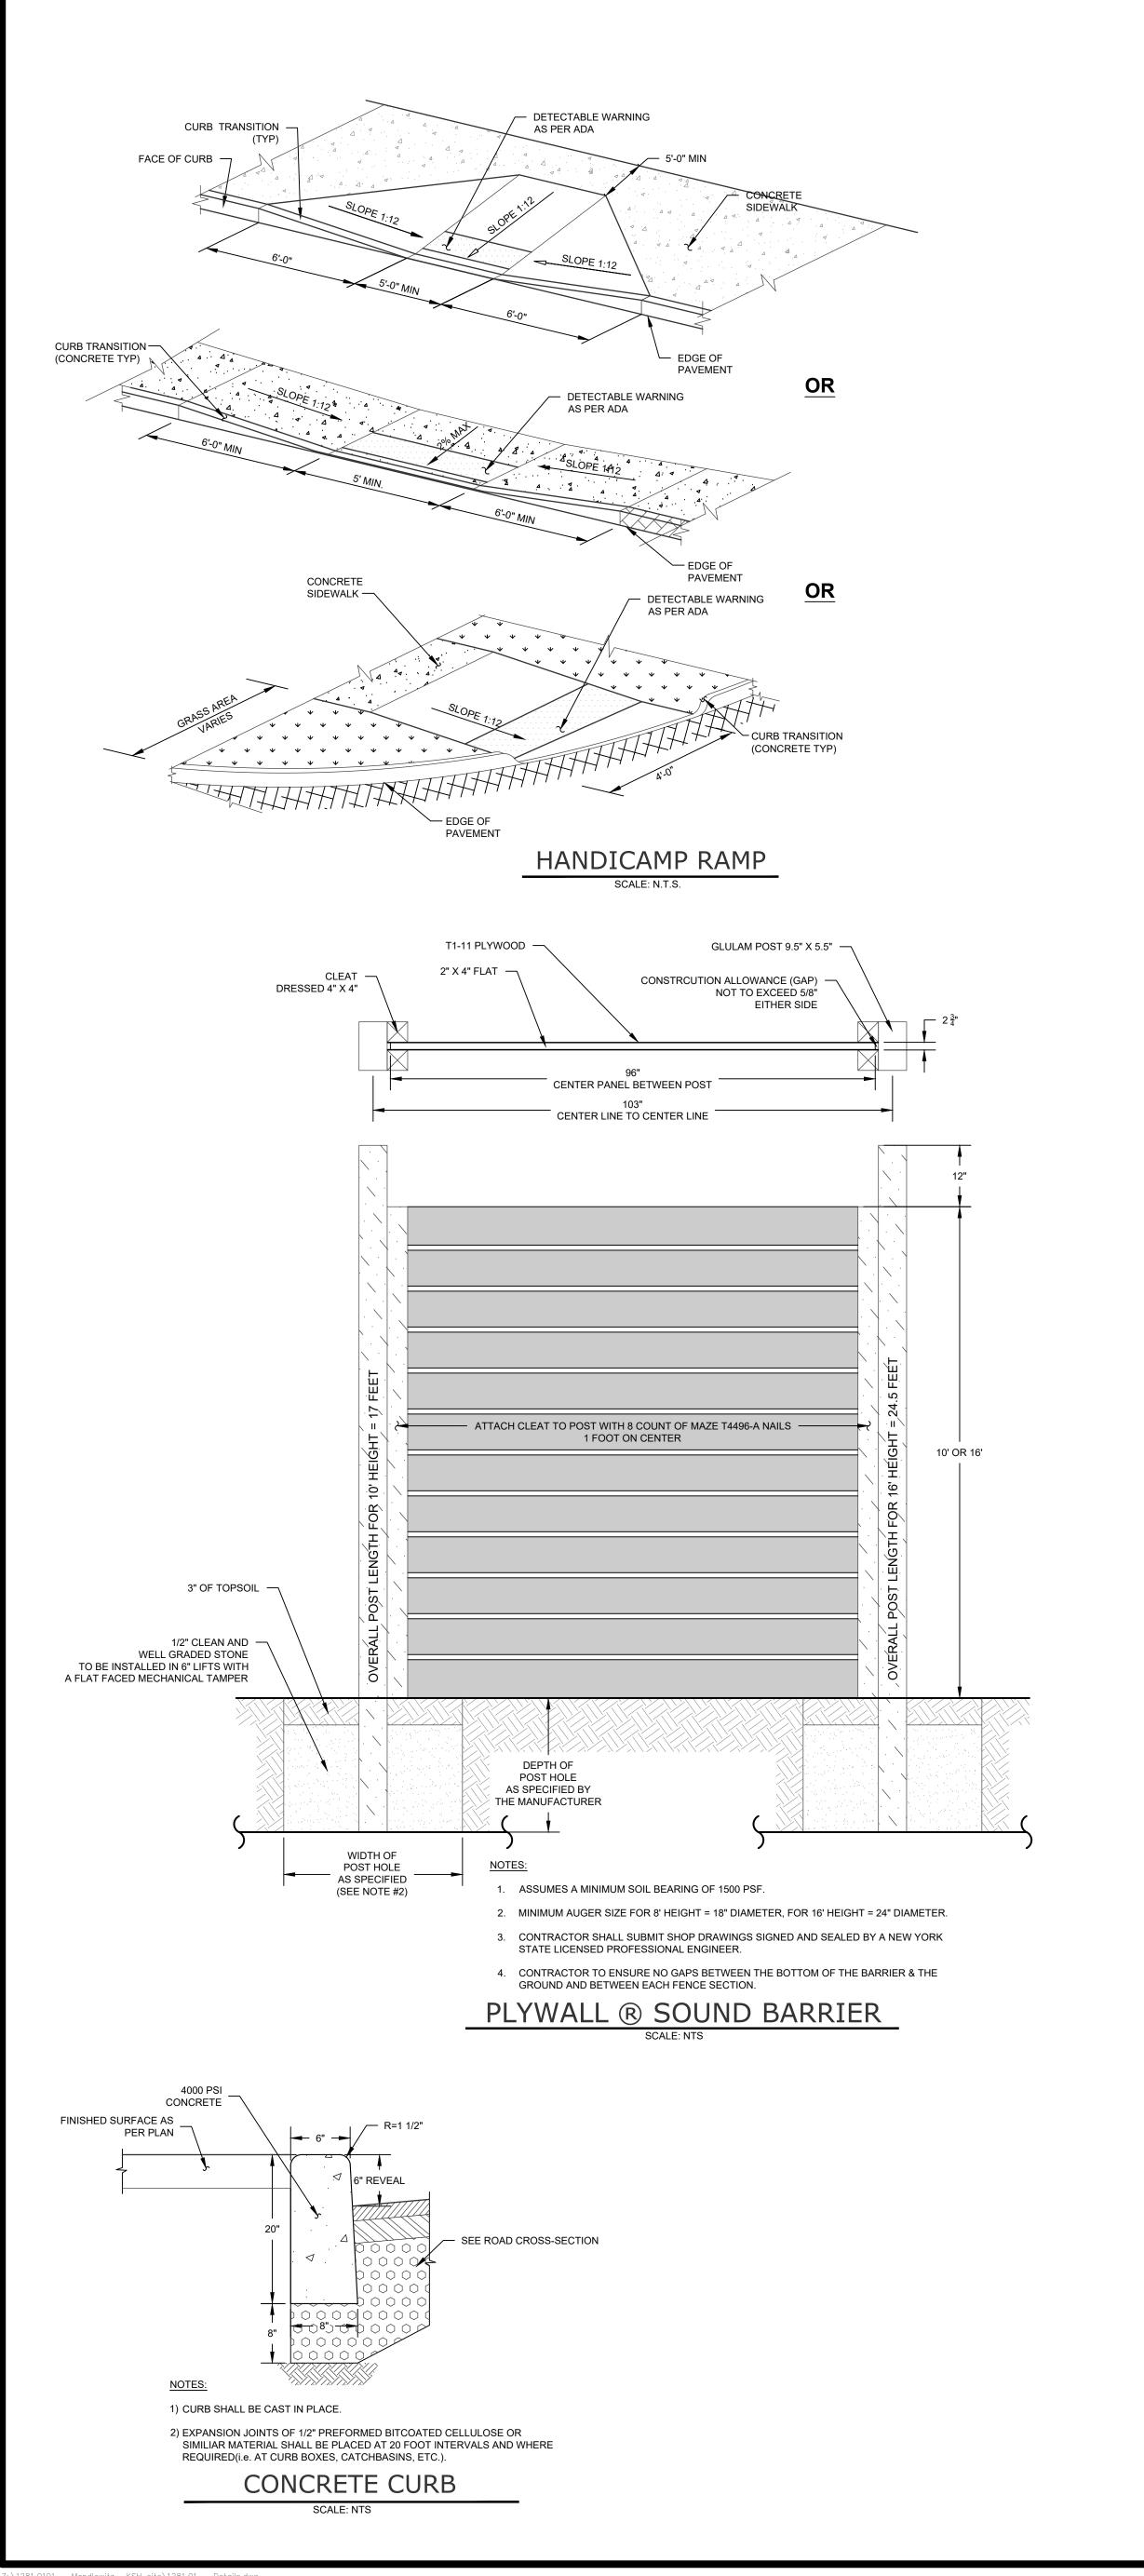


SIGN	TEXT	M.U.T.C.D. No.	SIZE OF SIGN	TYPE OF MOUNT	DESCRIPTION
NP	NO PARKING ANY TIME	P1-1C	12" x 18"	GR MTD	WHITE BACKGROUND RED LETTERING
STOP	STOP	R1-1C	36" x 36"	GR MTD	RED BACKGROUND WHITE LEGEND
НС	RESERVED PARKING BY PERMIT ONLY	M12-1	18" x 24"	GR MTD	BLUE BACKGROUND BLACK SYMBOL WHITE LETTERING
NTT	NO THRU TRUCK TRAFFIC	R14-3RA9	18" x 24"	GR MTD	WHITE BACKGROUND BLACK LETTERING
NLT	NO LEFT TURN FOR TRUCKS	K2-0783	30" x 30"	GR MTD	WHITE BACKGROUND RED & BLACK SYMBOL BLACK LETTERING
<b>→</b>	ALL TRUCKS	K2-0782-L	18" X 24"	GR MTD	WHITE BACKGROUND BLACK SYMBOL BLACK LETTERING
FL	NO PARKING FIRE LANE	R8-31	18" x 24"	GR MTD	WHITE BACKGROUND RED LETTERING

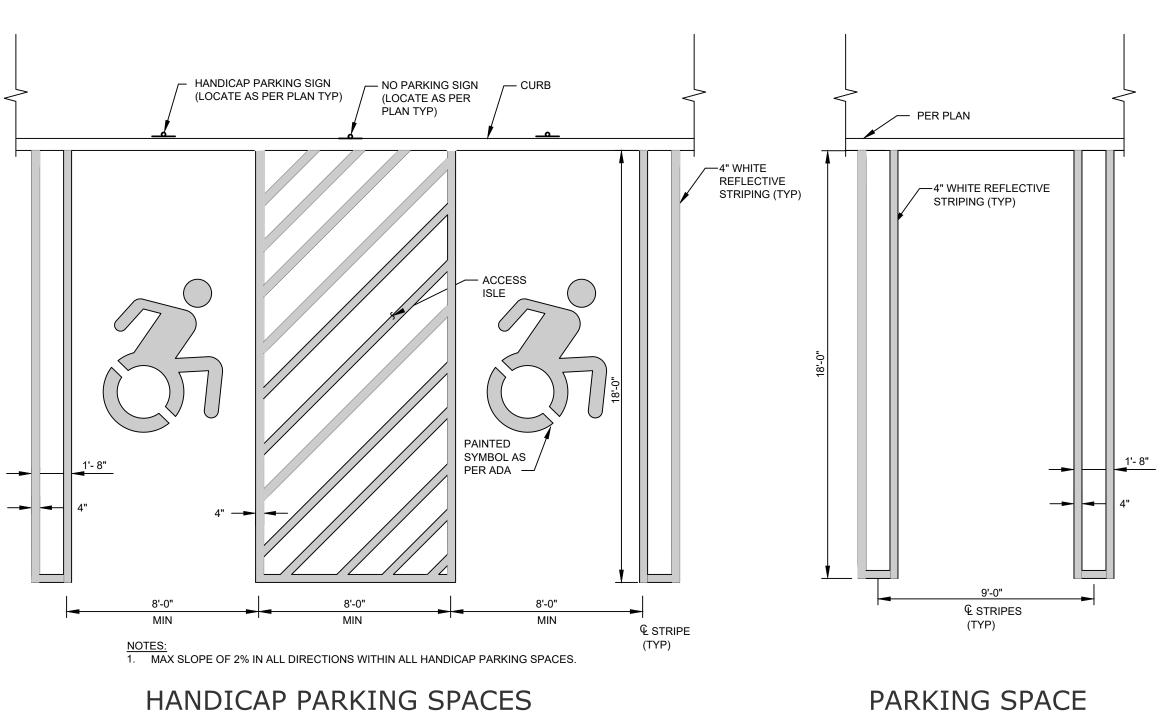

SCALE: N.T.S.

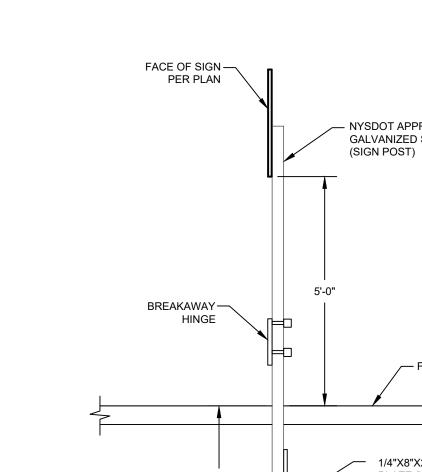


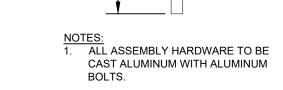



SIGN POST SCALE: NTS

PARKING SPACE	
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NTS					SCALE: NTS	
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SIGN	TEXT	M.U.T.C.D. No.	SIZE OF SIGN	TYPE OF MOUNT	DESCRIPTION	
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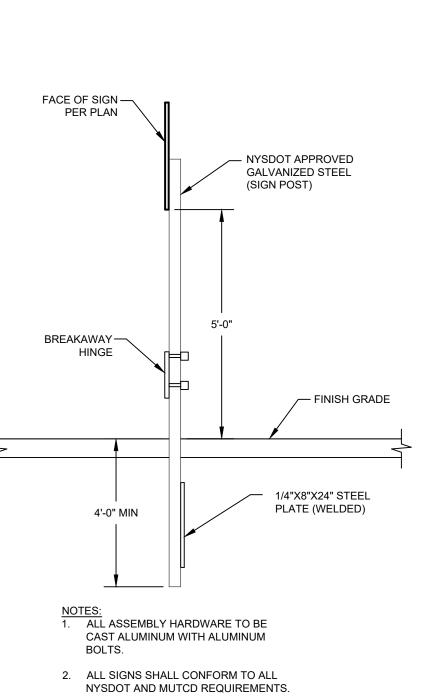


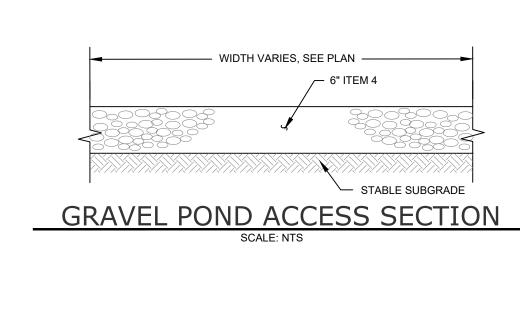

NOTES:

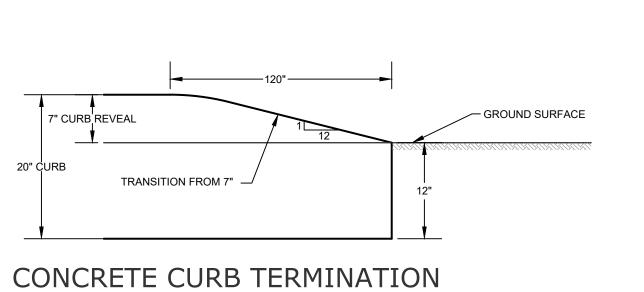1. GUIDERAIL MUST CONFORM WITH NYSDOT W-BEAM GUIDERAIL. REFER TO NYSDOT STANDARD SHEETS 606-06.

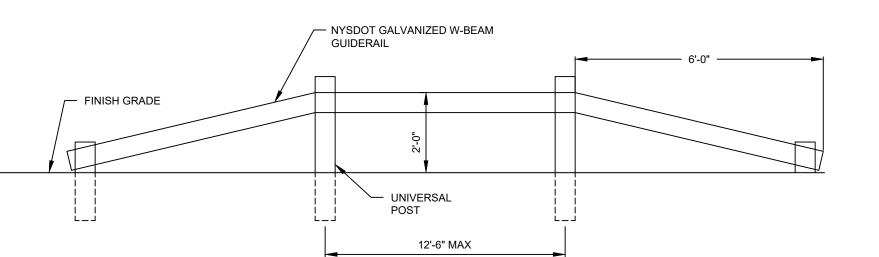NYS DOT W-BEAM GUIDE RAIL
SCALE: NTS



1<sup>1</sup>/<sub>2</sub>" ASPHALT CONCRETE — TYPE 6 TOP COURSE — 2.5" ASPHALT CONCRETE TYPE 1 BASE COURSE \_\_ 12" SUB-BASE ITEM 4 OR EQUIVALENT (MIRAFI 100X OR EQUAL) NOTES:

1. TO BE INSTALLED FOR PAVEMENT WITHIN PARKING AREAS AND ASILES. 2. ALL SUB-GRADE AND SUB-BASE SHALL BE PROOF ROLLED WITH TOWN ENGINEER PRESENT PRIOR TO THE PLACEMENT OF SUBSEQUENT LIFTS. PARKING PAVEMENT SECTION

1½" ASPHALT CONCRETE — TYPE 6 TOP COURSE /--- 3" ASPHALT CONCRETE TYPE 1 BASE COURSE \_ 15" SUB-BASE ITEM 4 OR EQUIVALENT (MIRAFI 100X OR EQUAL) NOTES: (MIRAFI 100X OR EQUAL)

1. TO BE INSTALLED FOR PAVEMENT WITHIN ACCESS ROAD.

2. ALL SUB-GRADE AND SUB-BASE SHALL BE PROOF ROLLED WITH TOWN ENGINEER PRESENT PRIOR TO THE PLACEMENT OF SUBSEQUENT LIFTS.

ROADWAY PAVEMENT SECTION SCALE: NTS

- WIDTH PER PLAN -

18" REFLECTIVE PIANT

STOP BAR

WHITE STOP BAR -



No. DATE DESCRIPTION 01/14/22 REVISED PER PB COMMENTS 12/15/2021 05/13/22 REVISED LAYOUT PER TRAFFIC STUDY 06/10/22 REVISED PER PB COMMENTS 09/16/22 REVISED PER PB COMMENTS 2/22 REVISED PER PB COMMENTS 09/23/2022 23 REVISED PER PB & PUBLIC COMMENTS 04/14/23 REVISED PER PB & PUBLIC COMMENTS 8 05/12/23 REVISED PER PB & PUBLIC COMMENTS 9 06/16/23 REVISED PER PB & PUBLIC COMMENTS 0 | 12/03/24 | REVISED FOR PLANNING BOARD SUBMISSION

DRAWING STATUS	ISSUE DATE:			
	12/03/2024			
THIS SHEET IS PART OF	S	SHEET		
THE PLAN SET ISSUED FOR	NUMBER		ER	
☐ CONCEPT APPROVAL	N/A	OF	N/A	
☑ PLANNING BOARD APPROVAL	16	OF	16	
OCDOH REALTY SUBDIVISION APPROVAL	N/A	OF	N/A	
☐ OCDOH WATERMAIN EXTENSION APPROVAL	N/A	OF	N/A	
□NYSDEC APPROVAL	N/A	OF	N/A	
□ NYSDOT APPROVAL	N/A	OF	N/A	
□OTHER	N/A	OF	N/A	
☐ FOR BID	N/A	OF	N/A	
☐ FOR CONSTRUCTION	N/A	OF	N/A	
THIS PLAN SET HAS BEEN ISSUED SPECIFICALLY FOR THE APPROVAL OR ACTION NOTED ABOVE AND SHALL NOT BE USED FOR ANY OTHER PURPOSE. THIS SHEET SHALL BE CONSIDERED INVALID UNLESS ACCOMPANIED BY ALL SHEETS OF THE DENOTED PLAN SET(S).				

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2 OF THE NEW YORK STATE EDUCATION LAW.	ROSS WINGLOVITZ, P.E. NEW YORK LICENSE # 071701			
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ORIGINAL SCALE IN INCHES				

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JOB #: 1281.01	DRAWN BY:		2024	
DATE: 12/09/2021	SCALE: AS NOTED	C-304	© COPYRIGHT	
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